

DSH-METROPOLITAN SNF BLDG REPAIR PROJECT

11401 BLOOMFIELD AVE, NORWALK, CA 90650
DGS PROJECT # DGS000000142412

DSA STAMP



VICINITY MAP		FACILITY LOCATION PLAN	OSFM PLAN REVIEW TRIAGE DATA	APPLICABLE CODES
		<p>ALL PLAN SHEETS ARE PRESENT AND REPRESENTED ON THE SHEET INDEX ALL SHEETS HAVE BEEN STAMPED AND WET SIGNED CALIFORNIA STATE FIRE MARSHAL'S FILE NUMBER SCOPE OF WORK - SEE "PROJECT DESCRIPTION" SITE MAP WITH COMPASS INDICATING NORTH - SEE "LOCATION MAP" KEY PLAN WHERE APPLICABLE INDICATING NORTH - SEE PLANS LIST OF DEFERRED SUBMITTALS - N/A LOCAL FIRE AUTHORITY ACCESS APPROVAL LETTER - N/A APPLICABLE CODE LISTINGS AND STANDARDS FOR PROJECT - SEE "APPLICABLE CODES" AND "LIST OF APPLICABLE STANDARDS" COMPLETE BUILDING ANALYSIS - SEE "BUILDING ANALYSIS" DRAWINGS ARE TO SCALE DRAWINGS INDICATING NORTH - SEE PLAN SHEETS FLOOR PLANS TO IDENTIFY USE AND PROVIDE ROOM NUMBER - SEE PLANS EXITING PLAN TO IDENTIFY EGRESS PATH OF TRAVEL TO A PUBLIC RIGHT-OF-WAY - N/A FIRE ALARM, FIRE SPRINKLERS NOT REQUIRED FOR THIS SCOPE.</p>	<p>2019 BUILDING STANDARDS ADMINISTRATIVE CODE, PART 1, TITLE 24 C.C.R. 2019 CALIFORNIA EXISTING BUILDING CODE, PART 10, TITLE 24 C.C.R. (2018 INTERNATIONAL EXISTING BUILDING CODE) 2019 CALIFORNIA BUILDING CODE (CBC), PART 2, TITLE 24 C.C.R. (2018 INTERNATIONAL BUILDING CODE VOLUMES 1-2 AND 2020 CALIFORNIA AMENDMENTS) 2019 CALIFORNIA ELECTRICAL CODE (CEC), PART 3, TITLE 24 C.C.R. (2017 NATIONAL ELECTRICAL CODE AND 2019 CALIFORNIA AMENDMENTS) 2019 CALIFORNIA MECHANICAL CODE (CMC) PART 4, TITLE 24 C.C.R. (2018 UNIFORM MECHANICAL CODE AND 2019 CALIFORNIA AMENDMENTS) 2019 CALIFORNIA PLUMBING CODE (CPC), PART 5, TITLE 24 C.C.R. (2018 UNIFORM PLUMBING CODE AND 2019 CALIFORNIA AMENDMENTS) 2019 CALIFORNIA ENERGY CODE, PART 6, TITLE 24 C.C.R., EFFECTIVE JANUARY 1, 2020 2019 CALIFORNIA FIRE CODE, PART 9, TITLE 24 C.C.R. (2018 INTERNATIONAL FIRE CODE AND 2021 CALIFORNIA AMENDMENTS) 2019 GREEN CALIFORNIA BUILDING STANDARDS, CALGREEN CODE, TITLE 24, PART 11 2019 CALIFORNIA REFERENCED STANDARDS, PART 12, TITLE 24 C.C.R. TITLE 19 C.C.R., PUBLIC SAFETY, STATE FIRE MARSHAL REGULATIONS. <u>PARTIAL LIST OF APPLICABLE STATE STANDARDS</u> NFPA 13 AUTOMATIC SPRINKLER SYSTEMS NFPA 14 STANDPIPE SYSTEMS (CA AMENDED) NFPA 17 DRY CHEMICAL EXTINGUISHING SYSTEMS NFPA 17A WET CHEMICAL SYSTEMS NFPA 20 STATIONARY PUMPS NFPA 24 PRIVATE FIRE MAINS (CA AMENDED) NFPA 72 NATIONAL FIRE ALARM CODE (CA AMENDED) (NOTE SEE UL STANDARD 1971 FOR "VISUAL DEVICES") NFPA 80 FIRE DOOR AND OTHER OPENING PROTECTIVE NFPA 253 TEST FOR CRITICAL RADIANT FLUX OF FLOOR COVERING SYSTEMS NFPA 2001 CLEAN AGENT FIRE EXTINGUISHING SYSTEMS REFERENCE CODE SECTION FOR NFPA STANDARDS- 2019 CBC (SFM) CHAPTER 35 OSHPD 1 CATEGORY 4 BUILDING</p>	

BUILDING NAME	BLDG. NO.	AREA SQ. FT.	BLDG. HT.	NO. OF STORIES	CONSTRUCTION TYPE	OCCUPANCY	AREA OF PROJECT IN SQ. FT.	SEPARATED OR NON SEPARATED USE	ALLOWABLE AREA PER CBC	AREA/HEIGHT INCREASE	FIRE SPRINKLERS	FIRE ALARM / MANUAL OR AUTOMATIC	OTHER FIRE PROTECTION SYS.	SMOKE CONTROL SYS. Y/N?	OCCUPANT LOAD PER BLDG. / PER FLOOR	YEAR BLDG. CONSTRUCTED	IN A HIGH FIRE HAZARD SEVERITY ZONE Y/N?	SEISMIC JOINTS Y/N?	EMERGENCY RESPONDER RADIO COVERAGE
SKILLED NURSING FACILITY (SNF)	504	68,725	13'-0"±	1	I-A	I-2 & I-3	NA	NON SEPARATED	UNLIMITED	NO	YES	YES / AUTOMATIC	NO	NO	NO CHANGE	1958	NO	YES	YES

DRAWING INDEX			SCOPE OF WORK	ARCHITECTURAL SYMBOLS
DWG. NUMBER	DESCRIPTION	DWG. NUMBER	DESCRIPTION	
<u>GENERAL</u>				
T.O.1	TITLE SHEET INDEX, NOTES			
<u>ARCHITECTURAL</u>				
A1.1	UNIT 417 - EXISTING CONDITIONS PHOTOGRAPH PLAN	A3.1	DETAILS	
A1.1.1	UNIT 417 - EXISTING CONDITIONS PHOTOGRAPHS	A3.2	DETAILS	
A1.2	UNIT 418 - EXISTING CONDITIONS PHOTOGRAPH PLAN	A3.3	DETAILS	
A1.2.1	UNIT 418 - EXISTING CONDITIONS PHOTOGRAPHS			
A1.2.2	UNIT 418 - EXISTING CONDITIONS PHOTOGRAPHS			
A1.3	UNIT A SNF - EXISTING CONDITIONS PHOTOGRAPH PLAN			
A1.3.1	UNIT A SNF - EXISTING CONDITIONS PHOTOGRAPHS			
A1.3.2	UNIT A SNF - EXISTING CONDITIONS PHOTOGRAPHS			
A1.4	UNIT 419 - EXISTING CONDITIONS PHOTOGRAPH PLAN			
A1.4.1	UNIT 419 - EXISTING CONDITIONS PHOTOGRAPHS			
A1.5	UNIT 420 - EXISTING CONDITIONS PHOTOGRAPH PLAN			
A1.5.1	UNIT 420 - EXISTING CONDITIONS PHOTOGRAPHS			
A1.5.2	UNIT 420 - EXISTING CONDITIONS PHOTOGRAPHS			
A2.1	UNIT 417 CEILING PLAN			
A2.1.1	UNIT 417 CEILING FINISH PLAN			
A2.2	UNIT 418 CEILING PLAN			
A2.2.1	UNIT 418 CEILING FINISH PLAN			
A2.3	UNIT A SNF CEILING PLAN			
A2.3.1	UNIT A SNF CEILING FINISH PLAN			
A2.4	UNIT 419 CEILING PLAN			
A2.4.1	UNIT 419 CEILING FINISH PLAN			
A2.5	UNIT 420 CEILING PLAN			
A2.5.1	UNIT 420 CEILING FINISH PLAN			

Approval of this plan does not authorize or approve any omission or deviation from applicable regulations. Final approval is subject to full review by the State Fire Marshal. Plans shall be available on the project site at all times.


APR 19 2022

OFFICE OF THE STATE FIRE MARSHAL
APPROVAL FOR CONSTRUCTION ONLY
Reviewed by Jason Gulyas, DPM III

DSA Building Number --- Work Order -

Reference North Sheet Scale AS SHOWN

Sheet Number T0.1

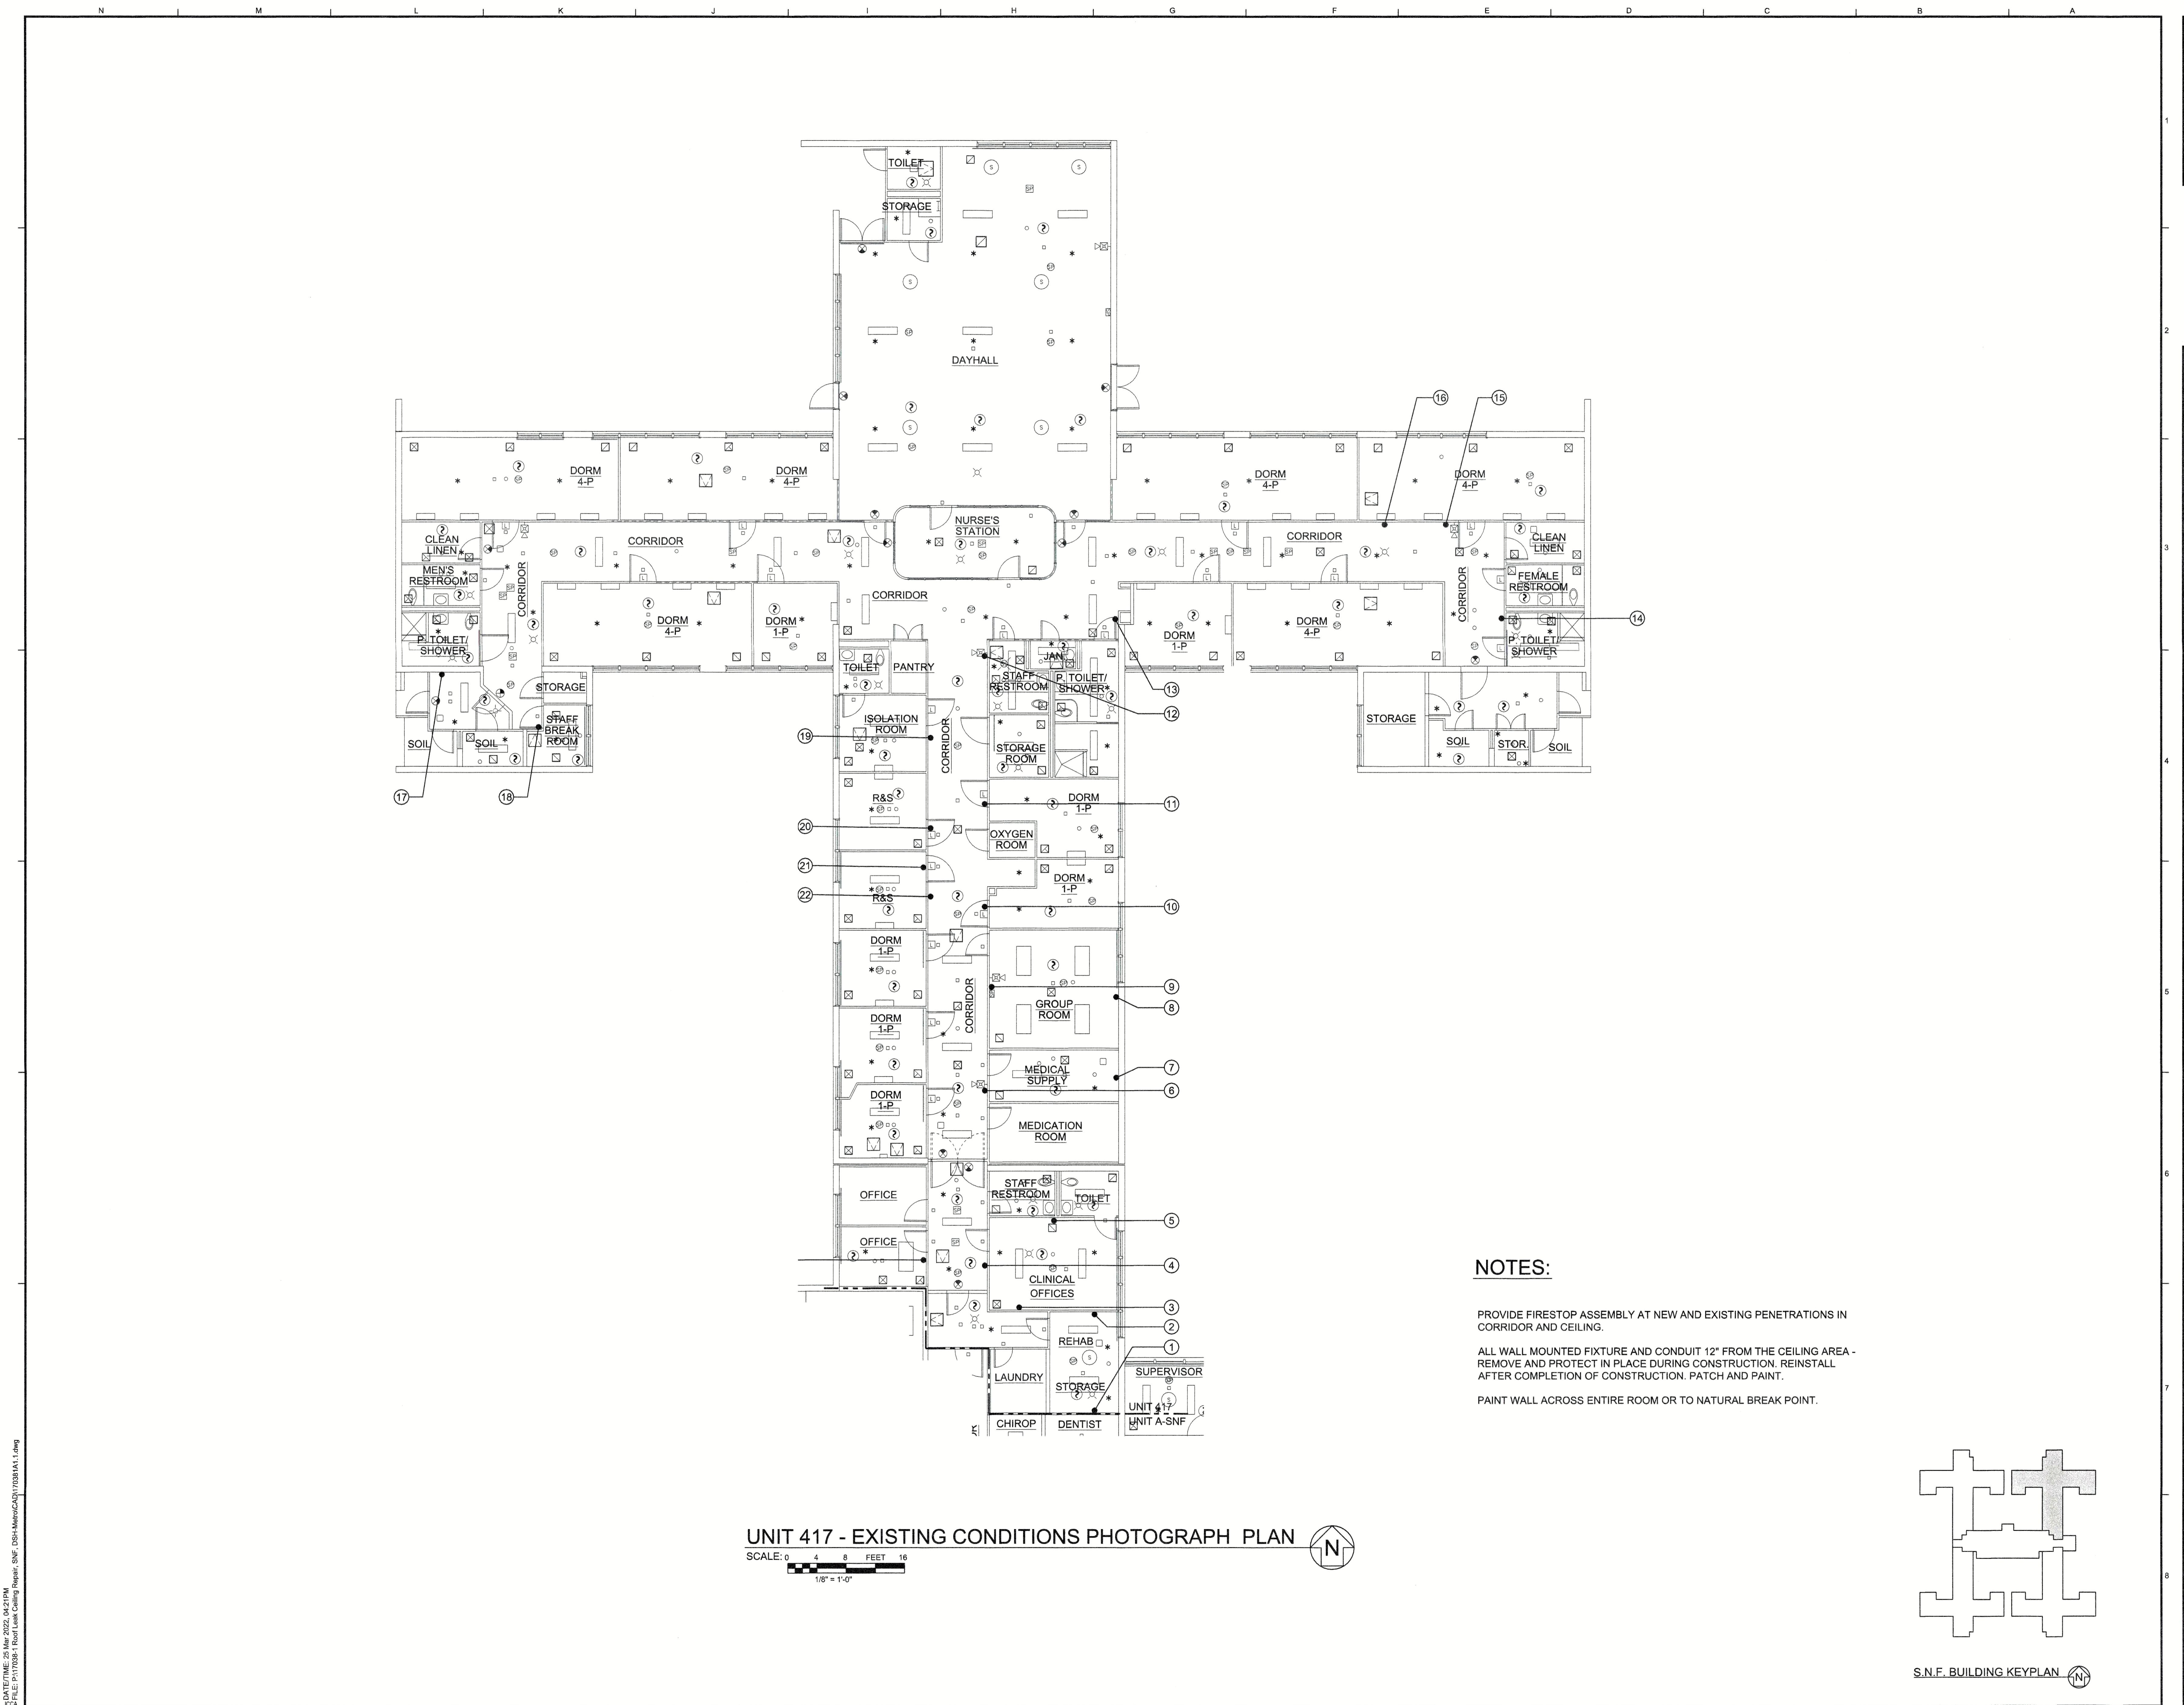

DSA STAMP


State of California
Department of General Services
Real Estate Services Division

Project Management Branch
707 Third Street, Suite 3-305
Sacramento, California 95605
Project Director:
(916) 445-0888 (Phone)
(916) 376-1677 (Fax)
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approved plans. All plans must be submitted
to field inspection. One set of approved plans
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Reviewed by _____
Jason Charles ESTM III



JCCA J.C. CHANG & ASSOCIATES, INC.
ENGINEERS • ARCHITECTS • PLANNERS
385 VAN NESS AVENUE • SUITE 208
TORRANCE, CALIFORNIA 90509
PH (310) 512-3354 FAX (310) 512-3272

JCCA #17038-1

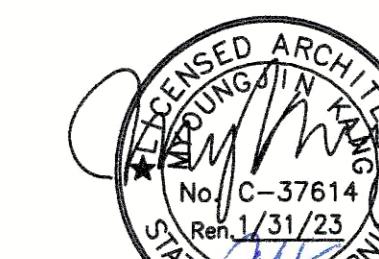Issue: 18-S-1084-C-PI
No. Date Description
- 11/01/21 FINAL DRAWINGS V1
- 3/2/22 FINAL DRAWINGS V2


Project
DSH-METROPOLITAN
SNF BLDG
RE-ROOF LEAK
DAMAGE REPAIR
PROJECT

11401 Bloomfield Ave.
Norwalk, CA 90650
Los Angeles County
DSA PROJECT # DGS0000014241C
SFM FAC #19-19-43-0002


Supervisor _____ Drawn _____ Checked _____
MJK Drawn V.L. Checked _____
File Date _____ Vault File Number _____

Sheet Title
UNIT 418 - EXISTING CONDITIONS PHOTOGRAPH PLAN

DSA Building Number _____ Work Order _____
Reference North _____ Sheet Scale _____ AS SHOWN
Sheet Number _____

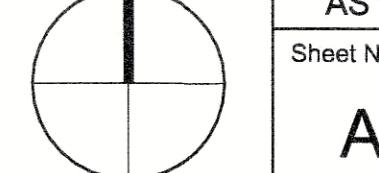

A1.2

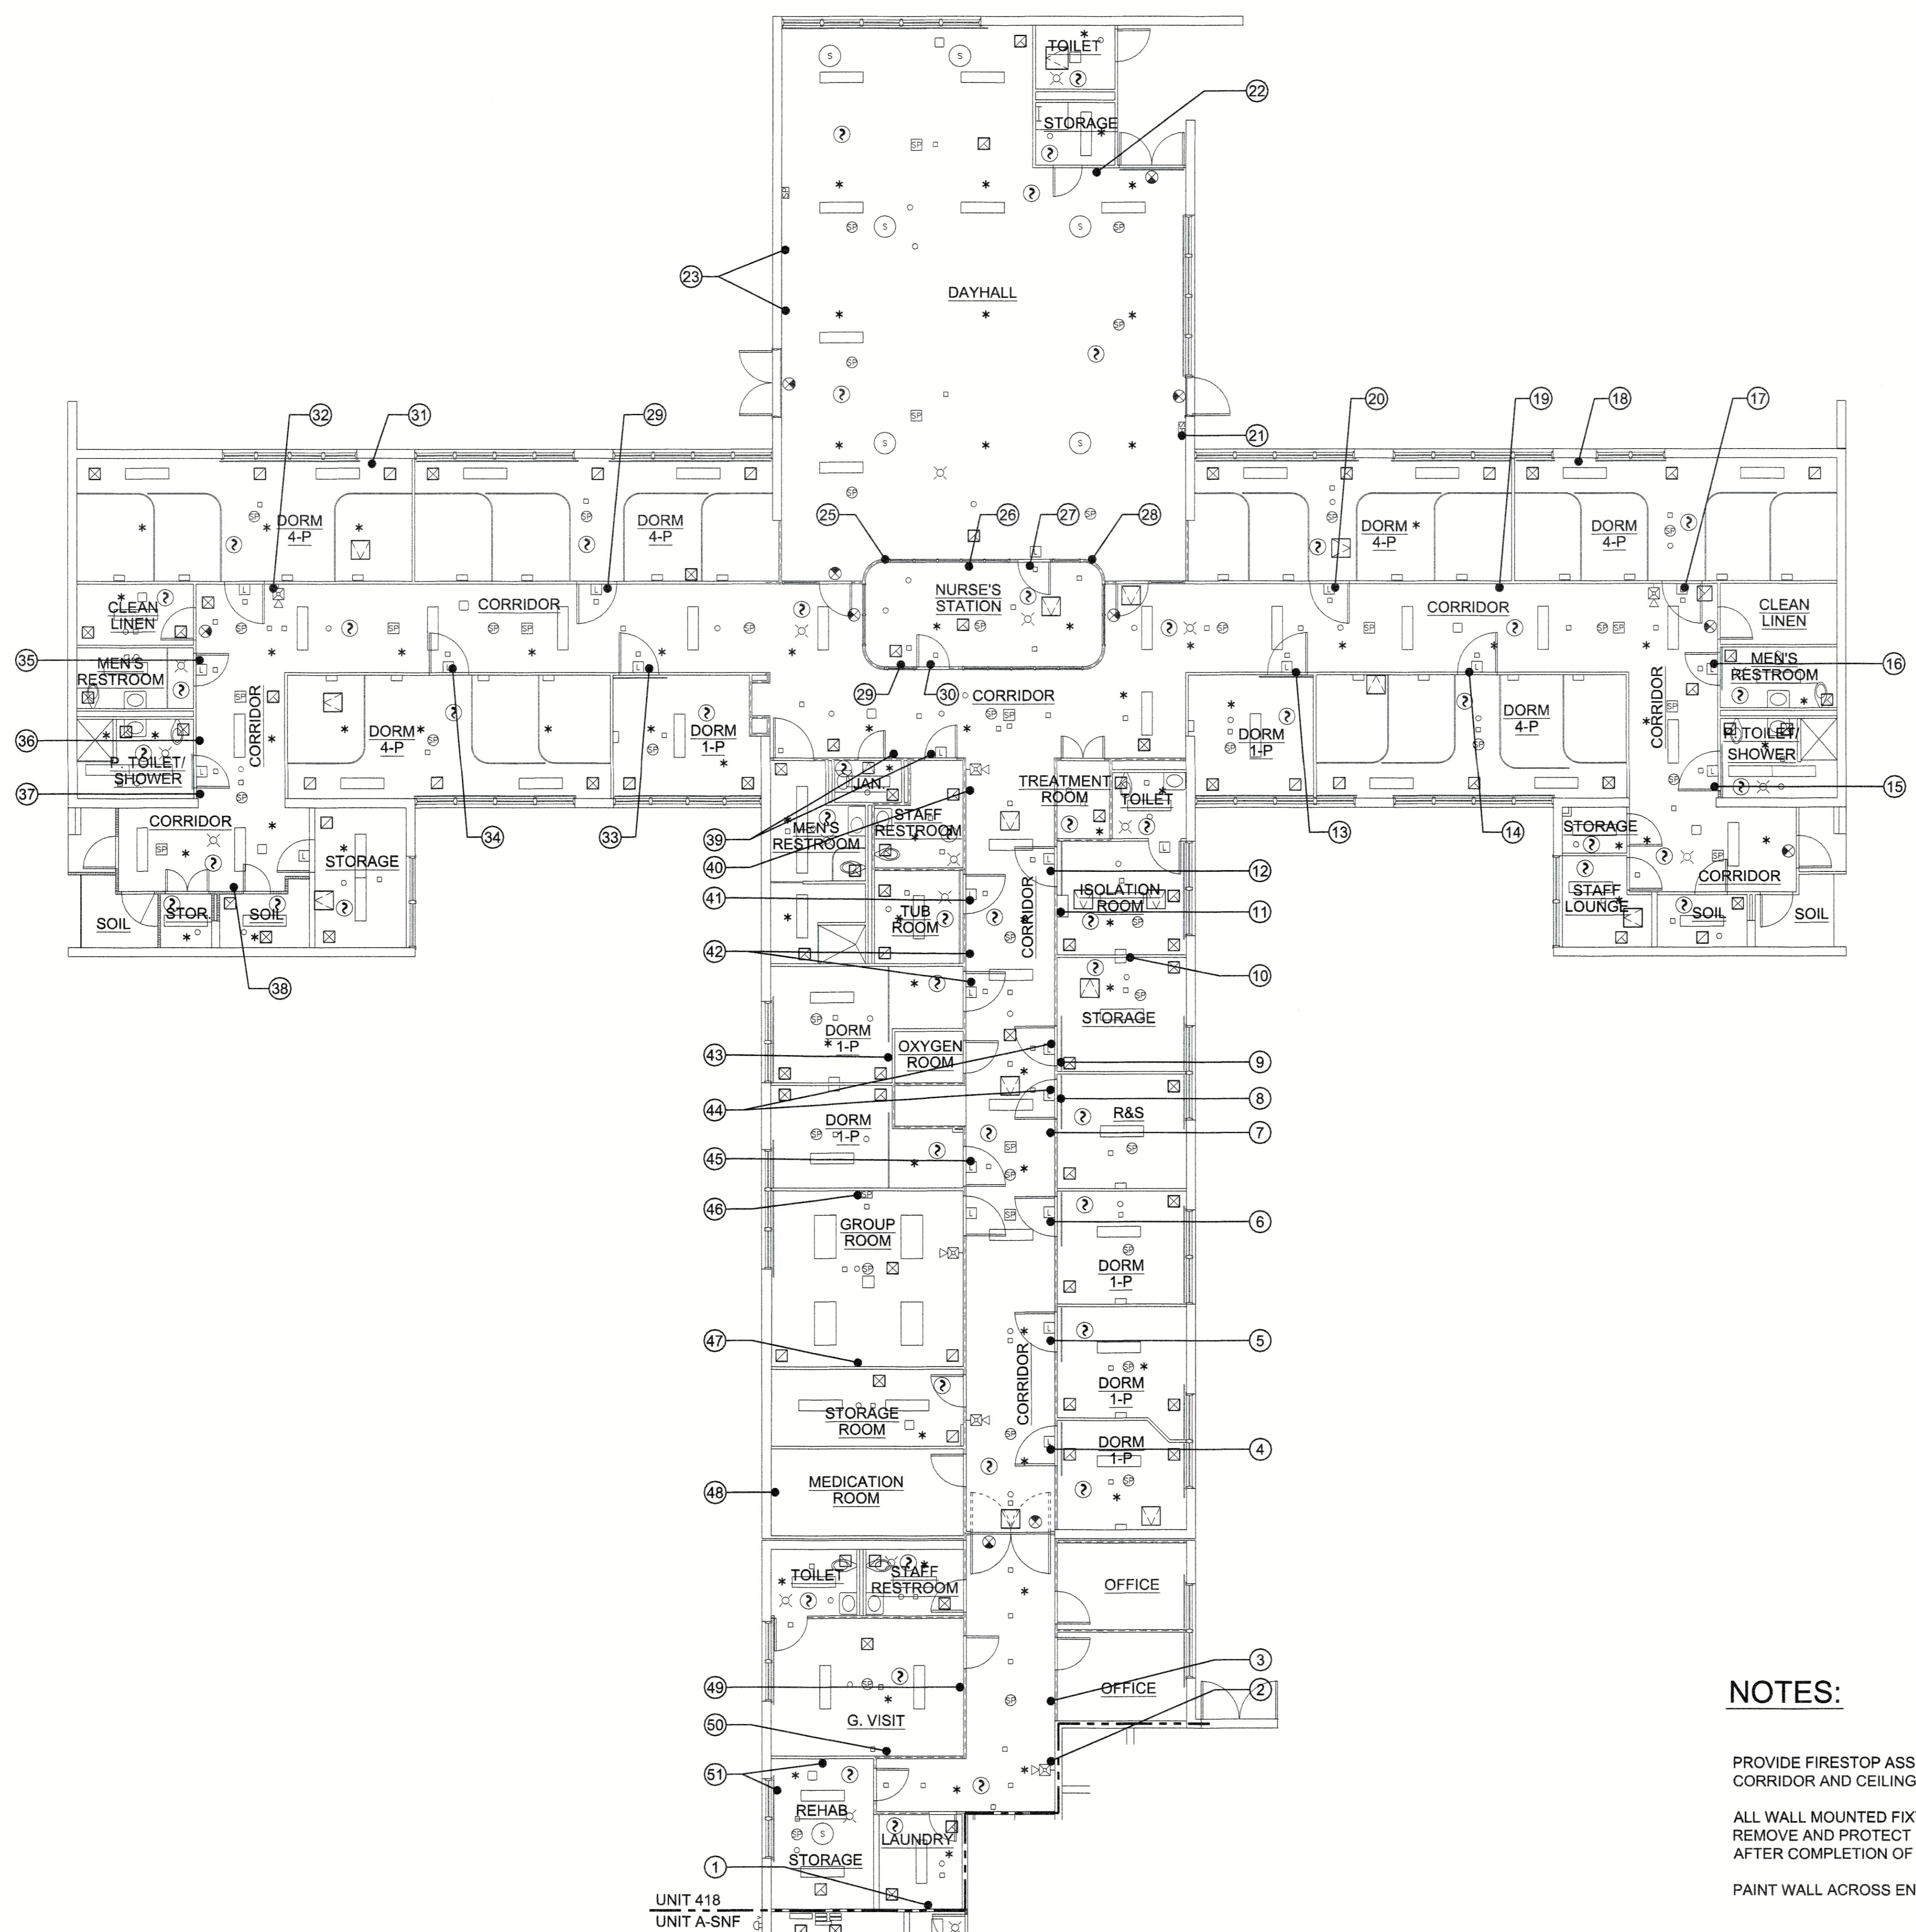

UNIT 418 - EXISTING CONDITIONS PHOTOGRAPH PLAN

SCALE: 0 4 8 FEET 16
1/8" = 1'-0"




NOTES:


PROVIDE FIRESTOP ASSEMBLY AT NEW AND EXISTING PENETRATIONS IN CORRIDOR AND CEILING.

ALL WALL MOUNTED FIXTURE AND CONDUIT 12" FROM THE CEILING AREA - REMOVE AND PROTECT IN PLACE DURING CONSTRUCTION. REINSTALL AFTER COMPLETION OF CONSTRUCTION. PATCH AND PAINT.

PAINT WALL ACROSS ENTIRE ROOM OR TO NATURAL BREAK POINT.

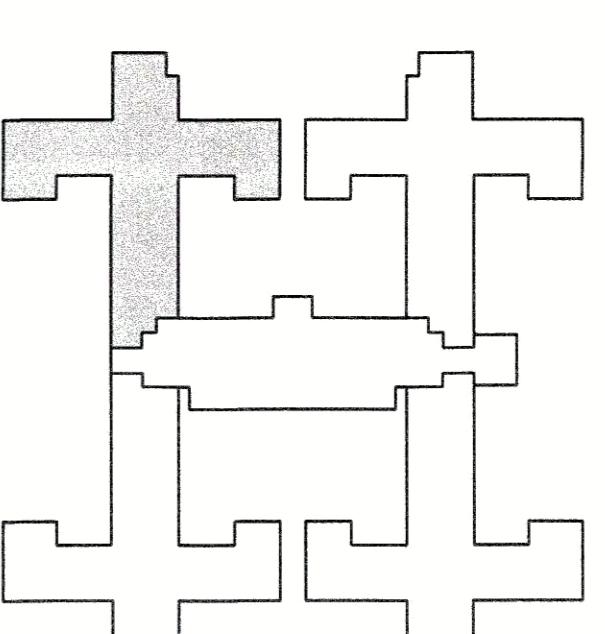

S.N.F. BUILDING KEYPLAN

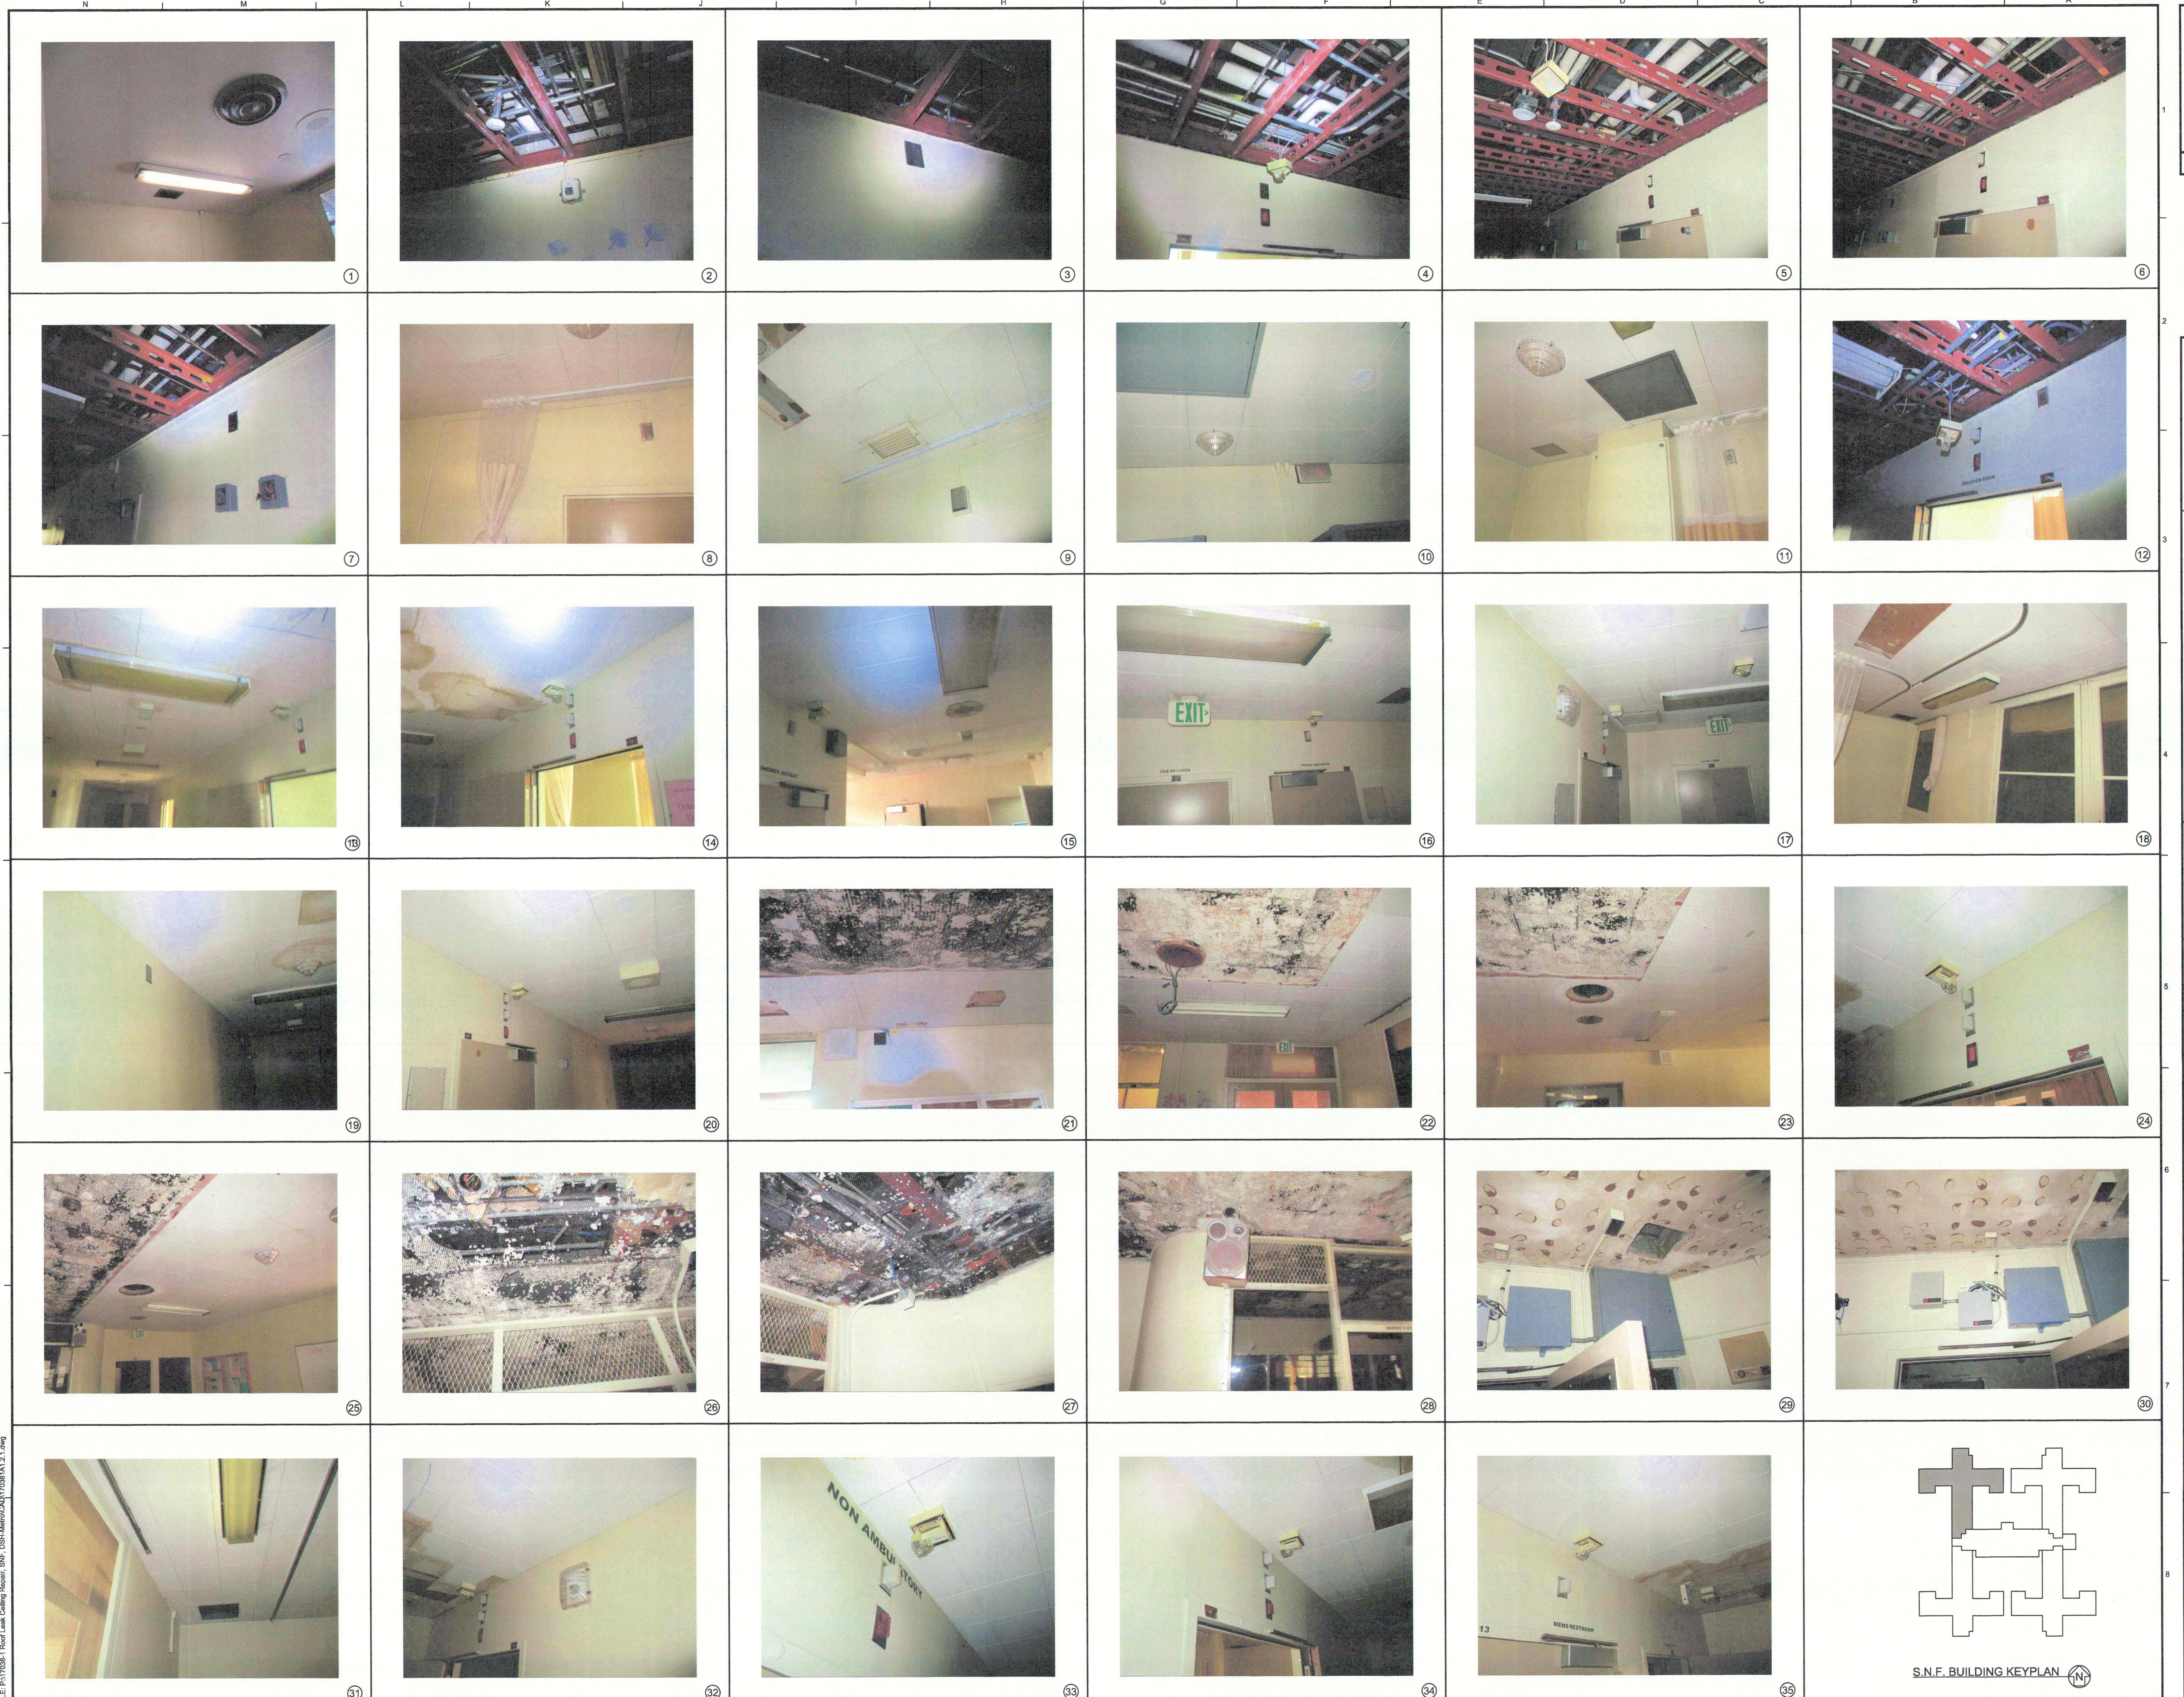

DSA STAMP

State of California
Department of General Services
Real Estate Services Division

Project Management Branch
707 Third Street, Suite 3-305
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Project Director:
(916) 445-1888 (Phone)
(916) 376-1677 (Fax)
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approve any erection or demolition from
applicable regulations. Final approval is sub-
ject to fire marshal's inspection. A copy of the
plan shall be available on the project site at all times.

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JCCA #17038-1

Issue:	18-S-1084-C-PI
No.	Date Description
-	11/01/21 FINAL DRAWINGS V1
-	3/2/22 FINAL DRAWINGS V2

Project
DSH-METROPOLITAN
SNF BLDG
RE-ROOF LEAK
DAMAGE REPAIR
PROJECT


11401 Bloomfield Ave.
Norwalk, CA. 90650
Los Angeles County
DGS PROJECT # DGS00000142412C
SFM FAC #19-19-43-0002

Supervisor *MJK* Designed *V.L.* Drawn *V.L.* Checked *MJK*

File Date - Vault File Number -

Sheet Title
UNIT A SNF - EXISTING
CONDITIONS
PHOTOGRAPH PLAN

DSA Building Number ---	Work Order -
Reference North 	Sheet Scale AS SHOWN
Sheet Number A1.3	

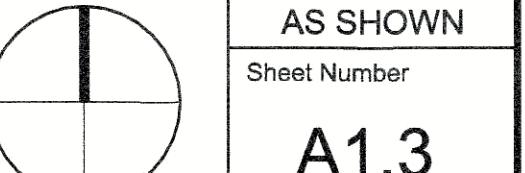

A1.3

PHASE 1 CEILING REPAIR - 3/24/22

UNIT A - EXISTING CONDITIONS PHOTOGRAPH PLAN


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1/8" = 1'-0"

NOTES:


PROVIDE FIRESTOP ASSEMBLY AT NEW AND EXISTING PENETRATIONS IN CORRIDOR AND CEILING.

ALL WALL MOUNTED FIXTURE AND CONDUIT 12" FROM THE CEILING AREA - REMOVE AND PROTECT IN PLACE DURING CONSTRUCTION. REINSTALL AFTER COMPLETION OF CONSTRUCTION. PATCH AND PAINT.

PAINT WALL ACROSS ENTIRE ROOM OR TO NATURAL BREAK POINT.

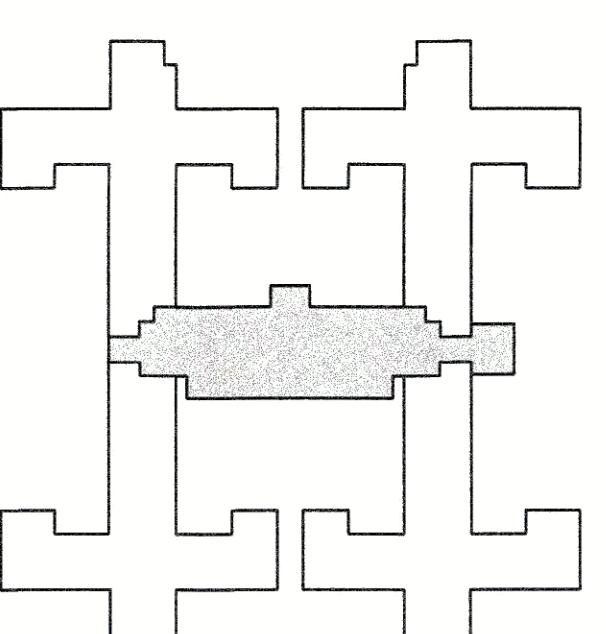

S.N.F. BUILDING KEYPLAN

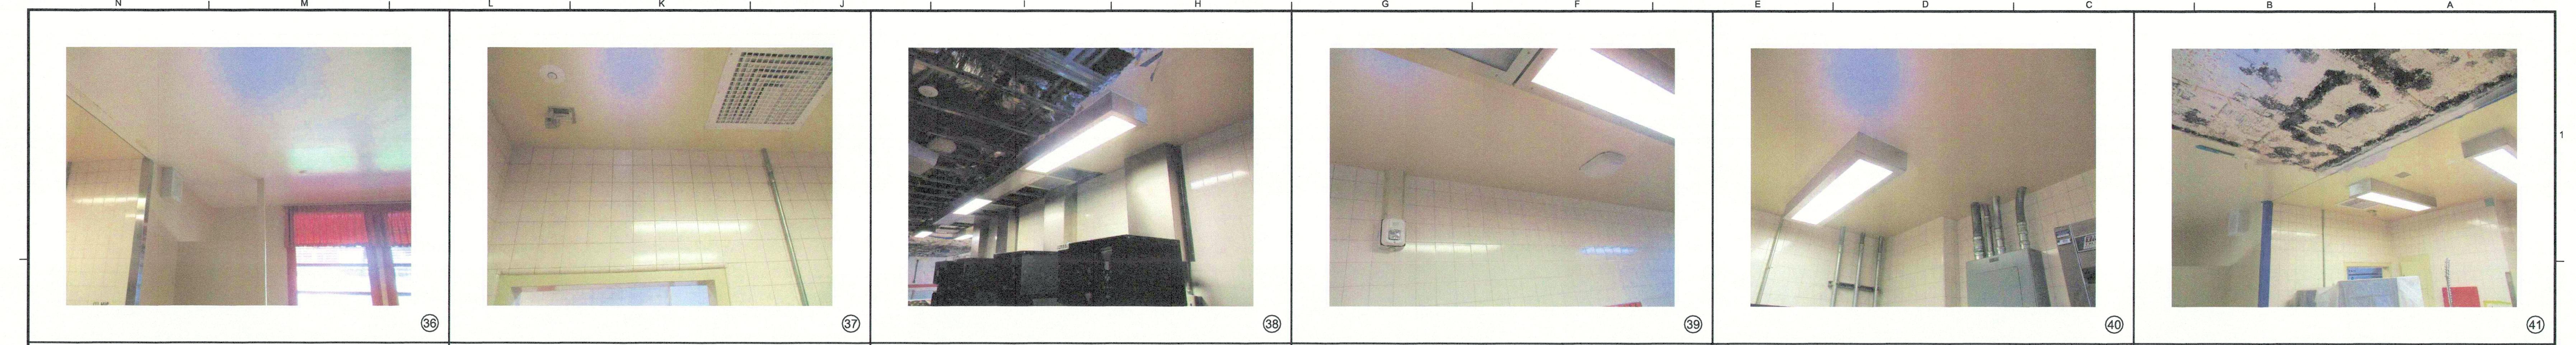

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jected to conditions, One set of plans
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FAX: 310/212-5272

JCCA #17038-1

Issue: 16-S-1084-C-PI
No. Date Description
- 11/01/21 FINAL DRAWINGS V1
- 3/2/22 FINAL DRAWINGS V2

Project
DSH-METRPOLITAN
SNF BLDG
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PROJECT

11401 Bloomfield Ave.
Norwalk, CA. 90650
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DGS PROJECT # DGS00000142412C
SFM FAC #19-19-43-0002

Supervisor Drawn Checked
MJK V.L. MJK
File Date Vault File Number


Sheet Title
UNIT A SNF - EXISTING
CONDITIONS
PHOTOGRAPHS

DSA Building Number Work Order
Reference North Sheet Scale
AS SHOWN
Sheet Number

(N)
A1.3.2


DATE/TIME: 25 Mar 2020 04:23PM
FILE: D17038-A1.3.2.wmg


PHASE 1 CEILING REPAIR - 3/24/22

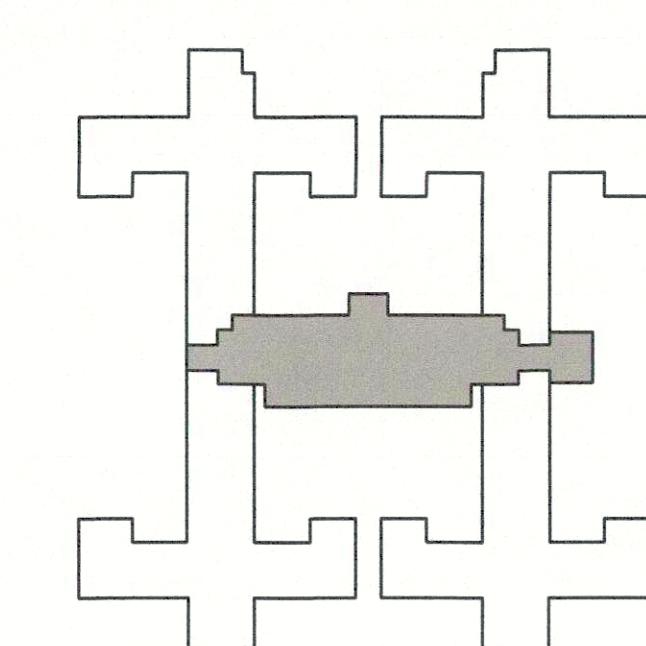


S.N.F. BUILDING KEYPLAN (N)

A1.3.2

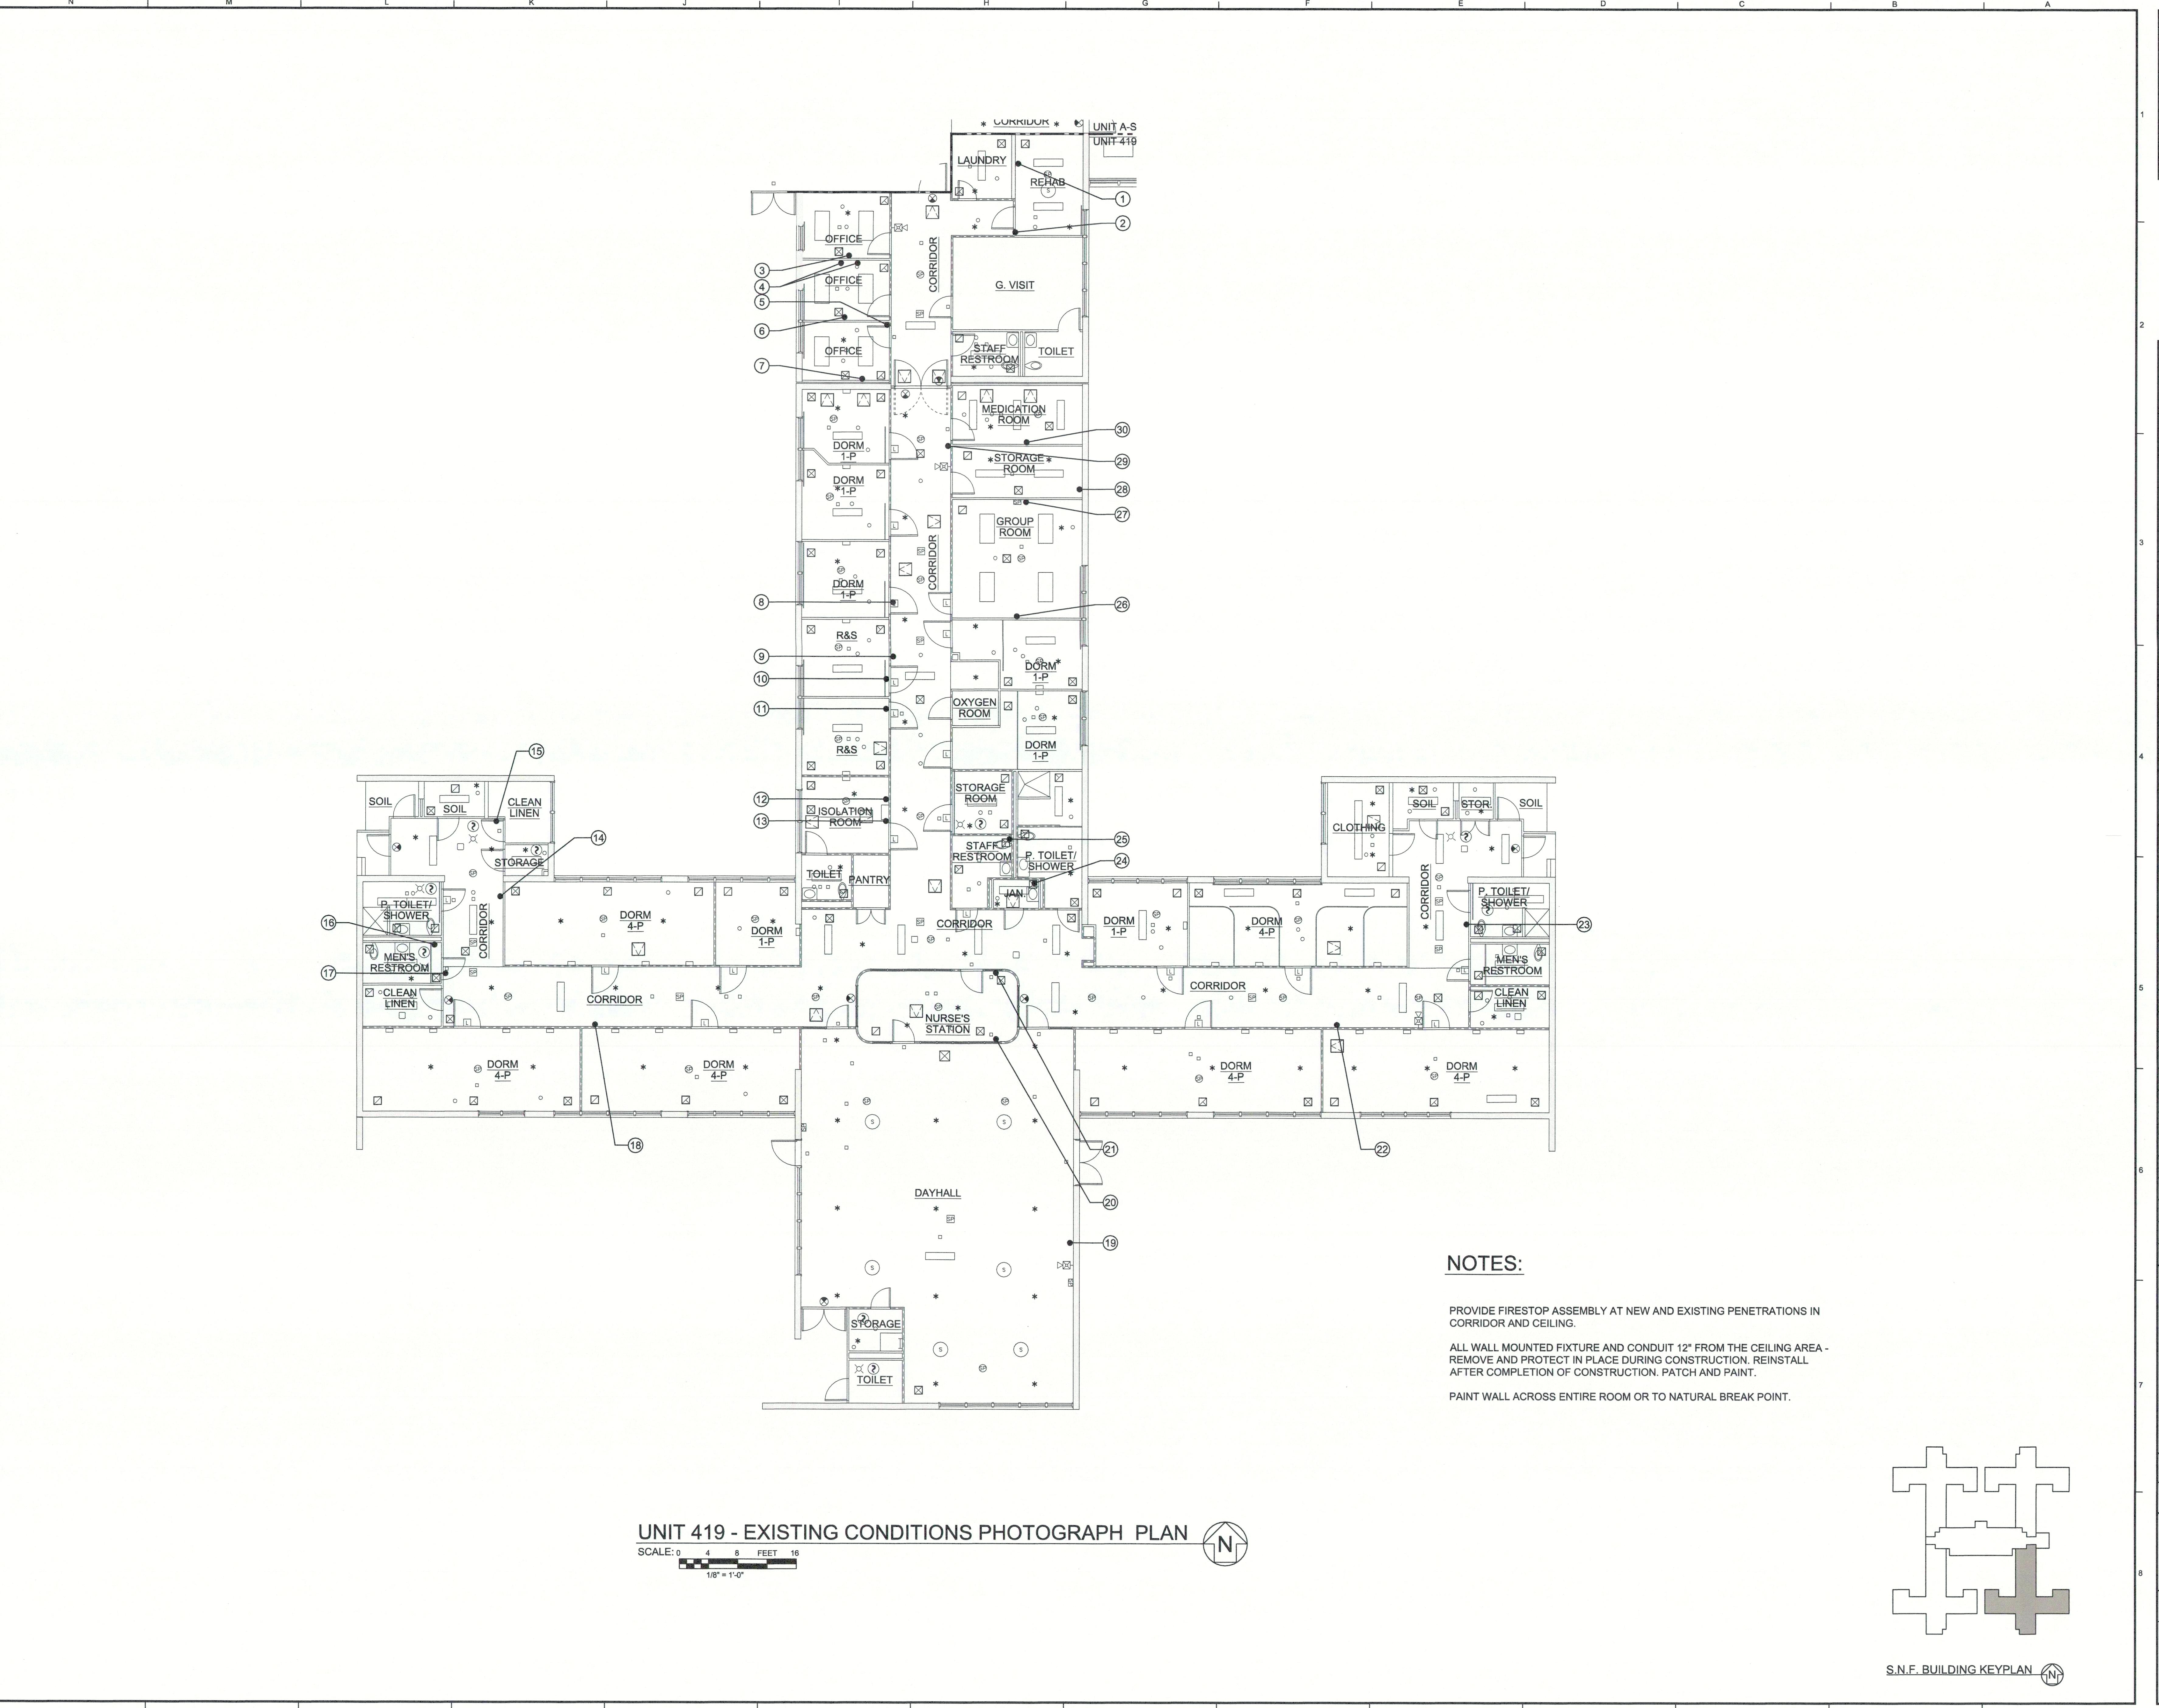


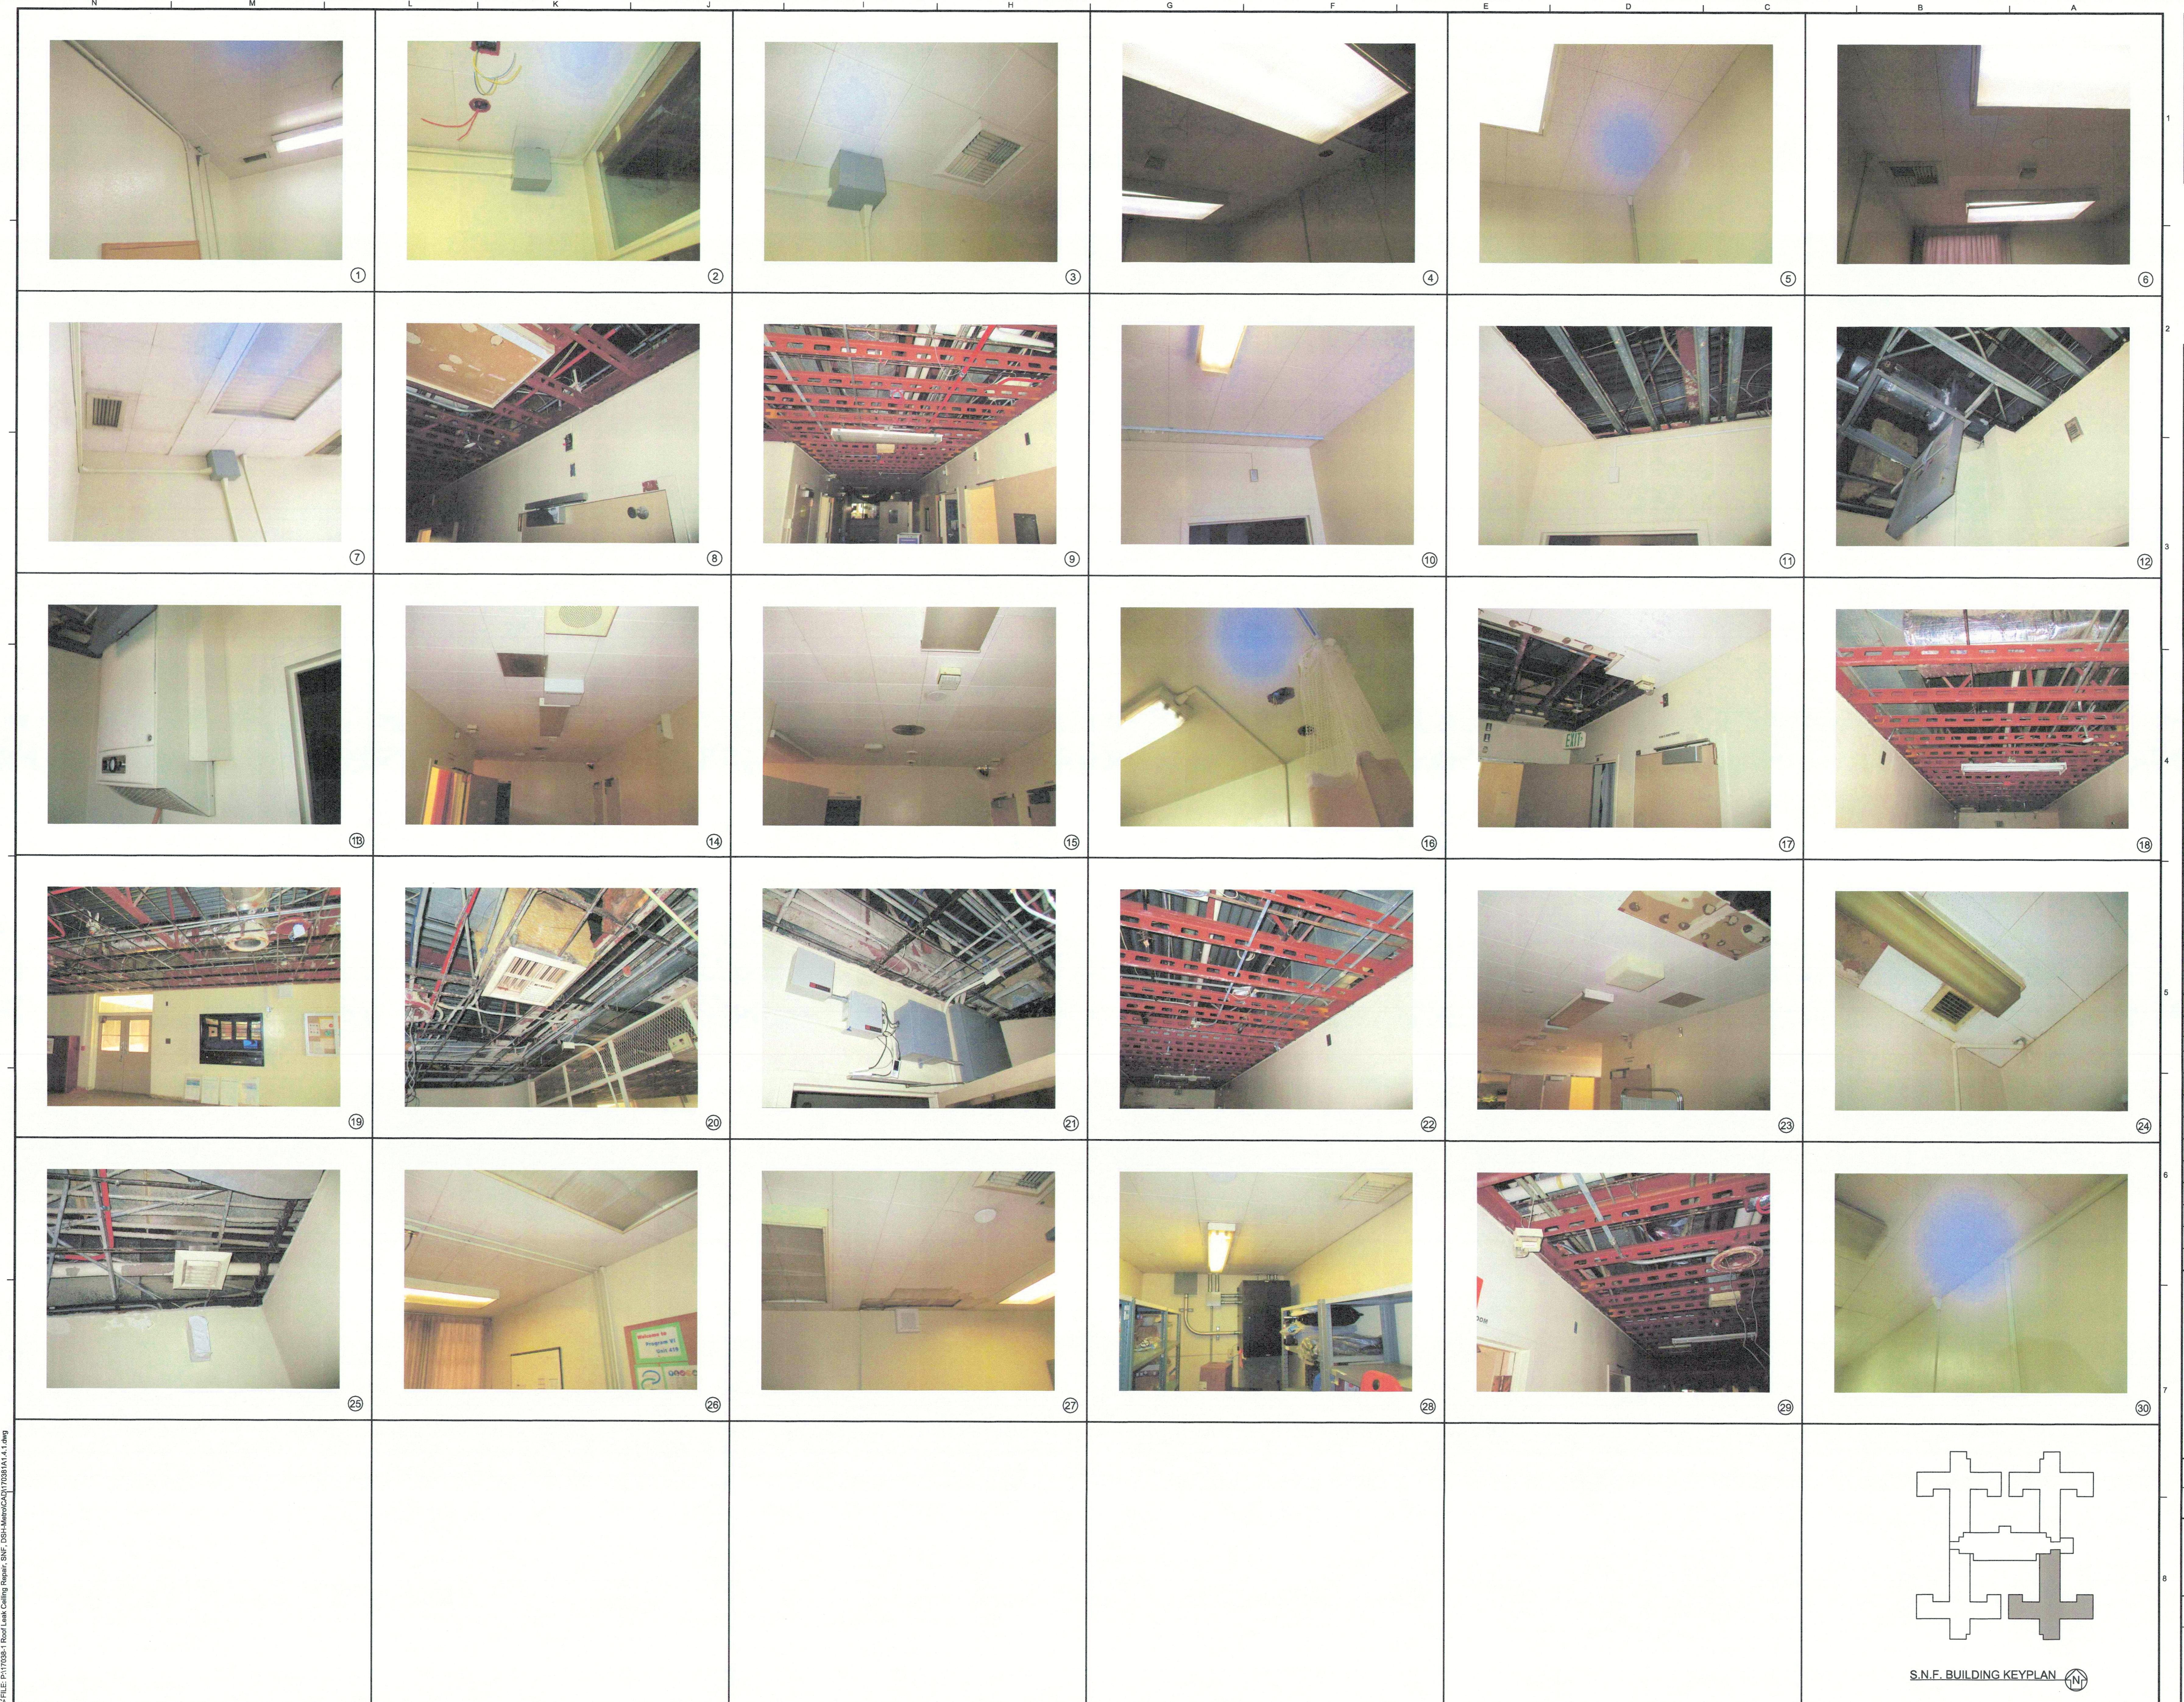

A horizontal timeline consisting of a black line with vertical tick marks and labels. The labels are: N, I, M, L, K, J, I, H, G, F, E, D, C, B, I, A. The labels are positioned above the line, except for 'I' which appears twice below the line.

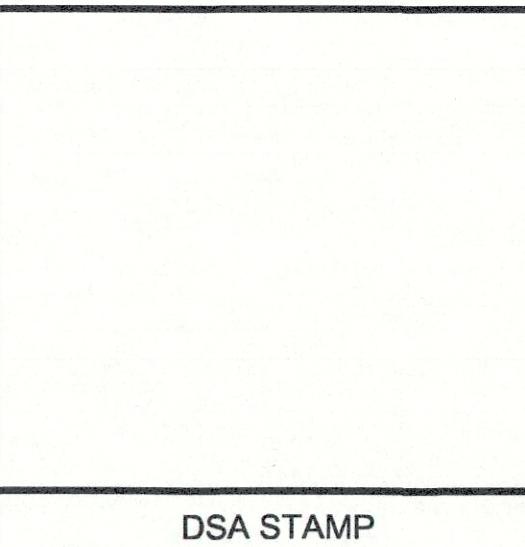

DSA STAMP

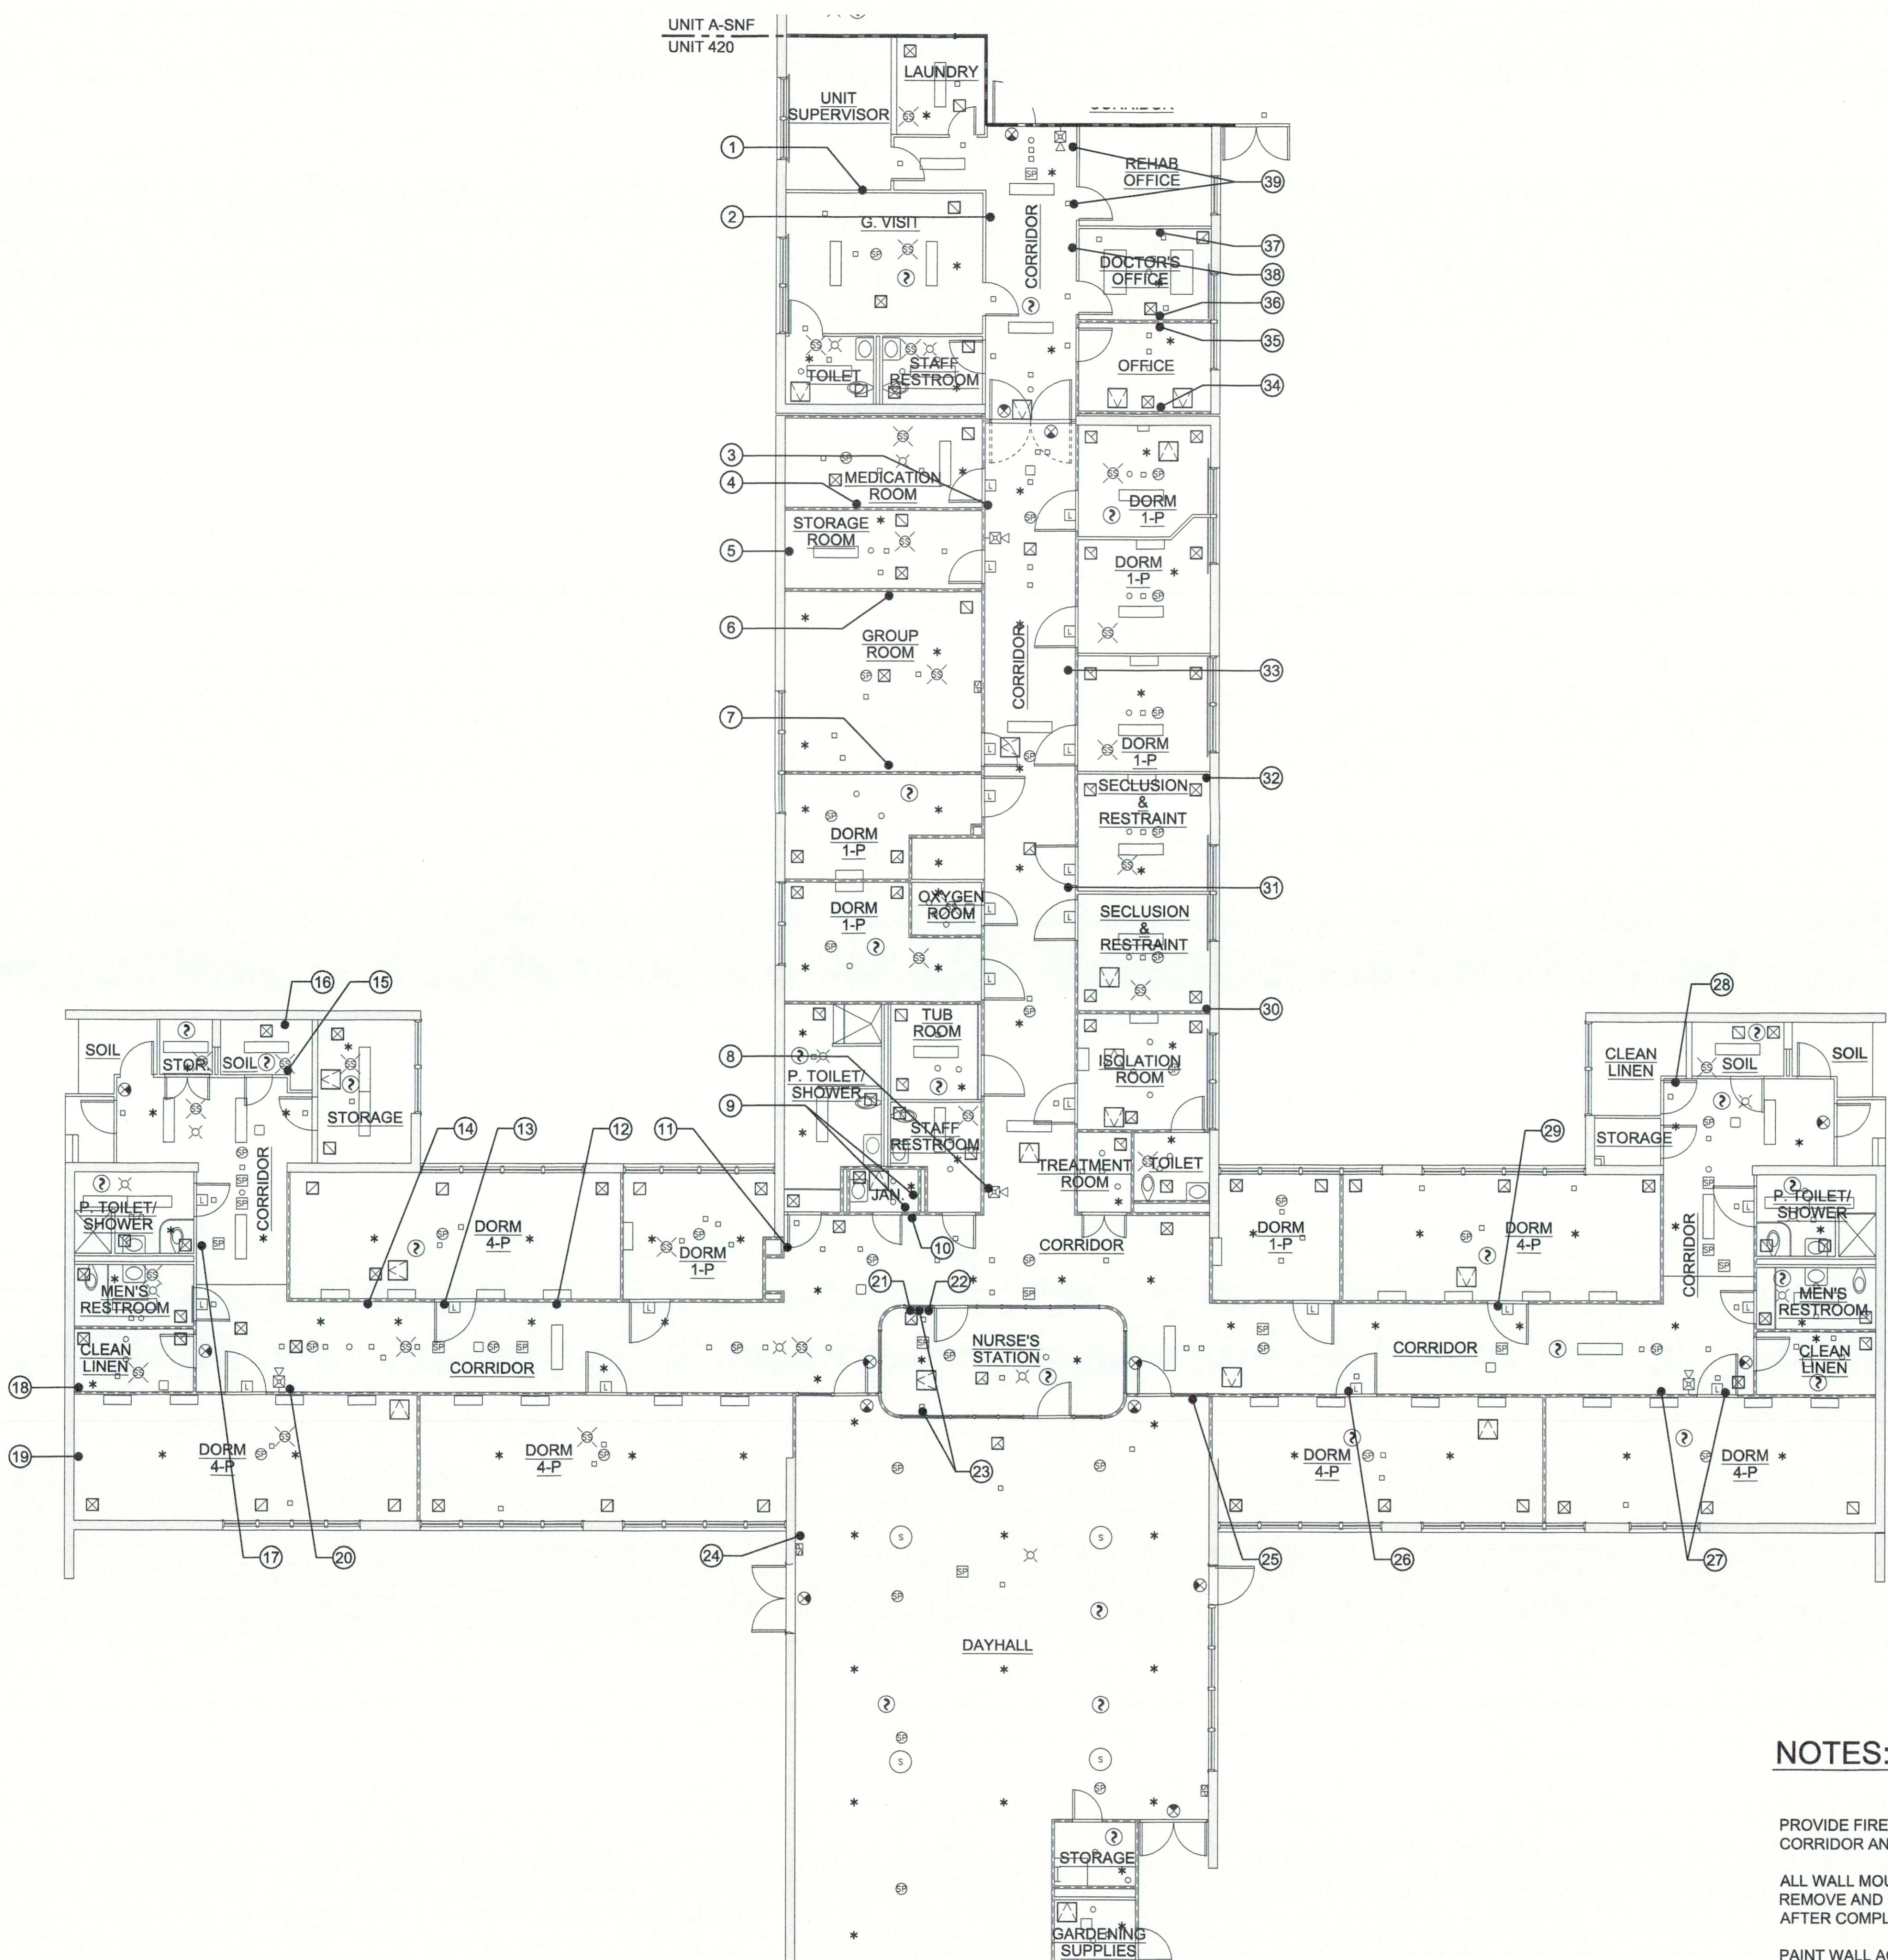


NOTES:

PROVIDE FIRESTOP ASSEMBLY AT NEW AND EXISTING PENETRATIONS IN CORRIDOR AND CEILING.

ALL WALL MOUNTED FIXTURE AND CONDUIT 12" FROM THE CEILING AREA - REMOVE AND PROTECT IN PLACE DURING CONSTRUCTION. REINSTALL AFTER COMPLETION OF CONSTRUCTION. PATCH AND PAINT.

PAINT WALL ACROSS ENTIRE ROOM OR TO NATURAL BREAK POINT.

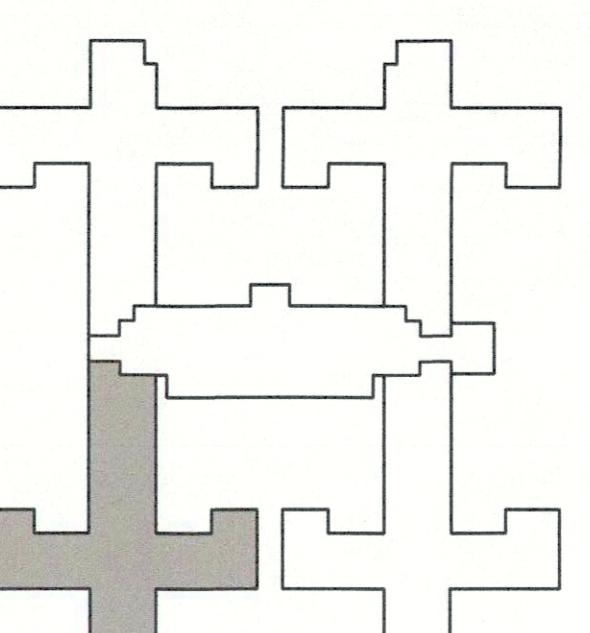

UNIT 420 - EXISTING CONDITIONS PHOTOGRAPH

SCALE: 0 4 8 FEET



1/8" = 1' 0"

AN
N

S.N.F. BUILDING KEYPLAN

State of California
Department of General Services
Real Estate Services Division



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707 Third Street, Suite 3-305
Sacramento, California 95605
Project Director:
(916) 443-9848 (Phone)
(916) 376-1677 (Fax)
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able on the project site at all tim

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Reviewed by: Joseph L. Johnson, DCEM III



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FAX (310) 212-5244

JCCA #17038-1		
Issue:	18-S-1084-C-PI	
No.	Date	Description
-	11/01/21	FINAL DRAWINGS V1
-	3/2/22	FINAL DRAWINGS V2

Project
DSH-METRPOLITAN
SNF BLDG
RE-ROOF LEAK
DAMAGE REPAIR
PROJECT

11401 Bloomfield Ave.
Norwalk, CA. 90650
Los Angeles County


Supervisor MJK	Designed	Drawn V.L.	Checked MJK
File Date		Vault File Number	

Sheet Title

**UNIT 420 - EXISTING
CONDITIONS**

PHOTOGRAPH PLAN

Sheet Scale
AS SHOWN
Sheet Number
A 15

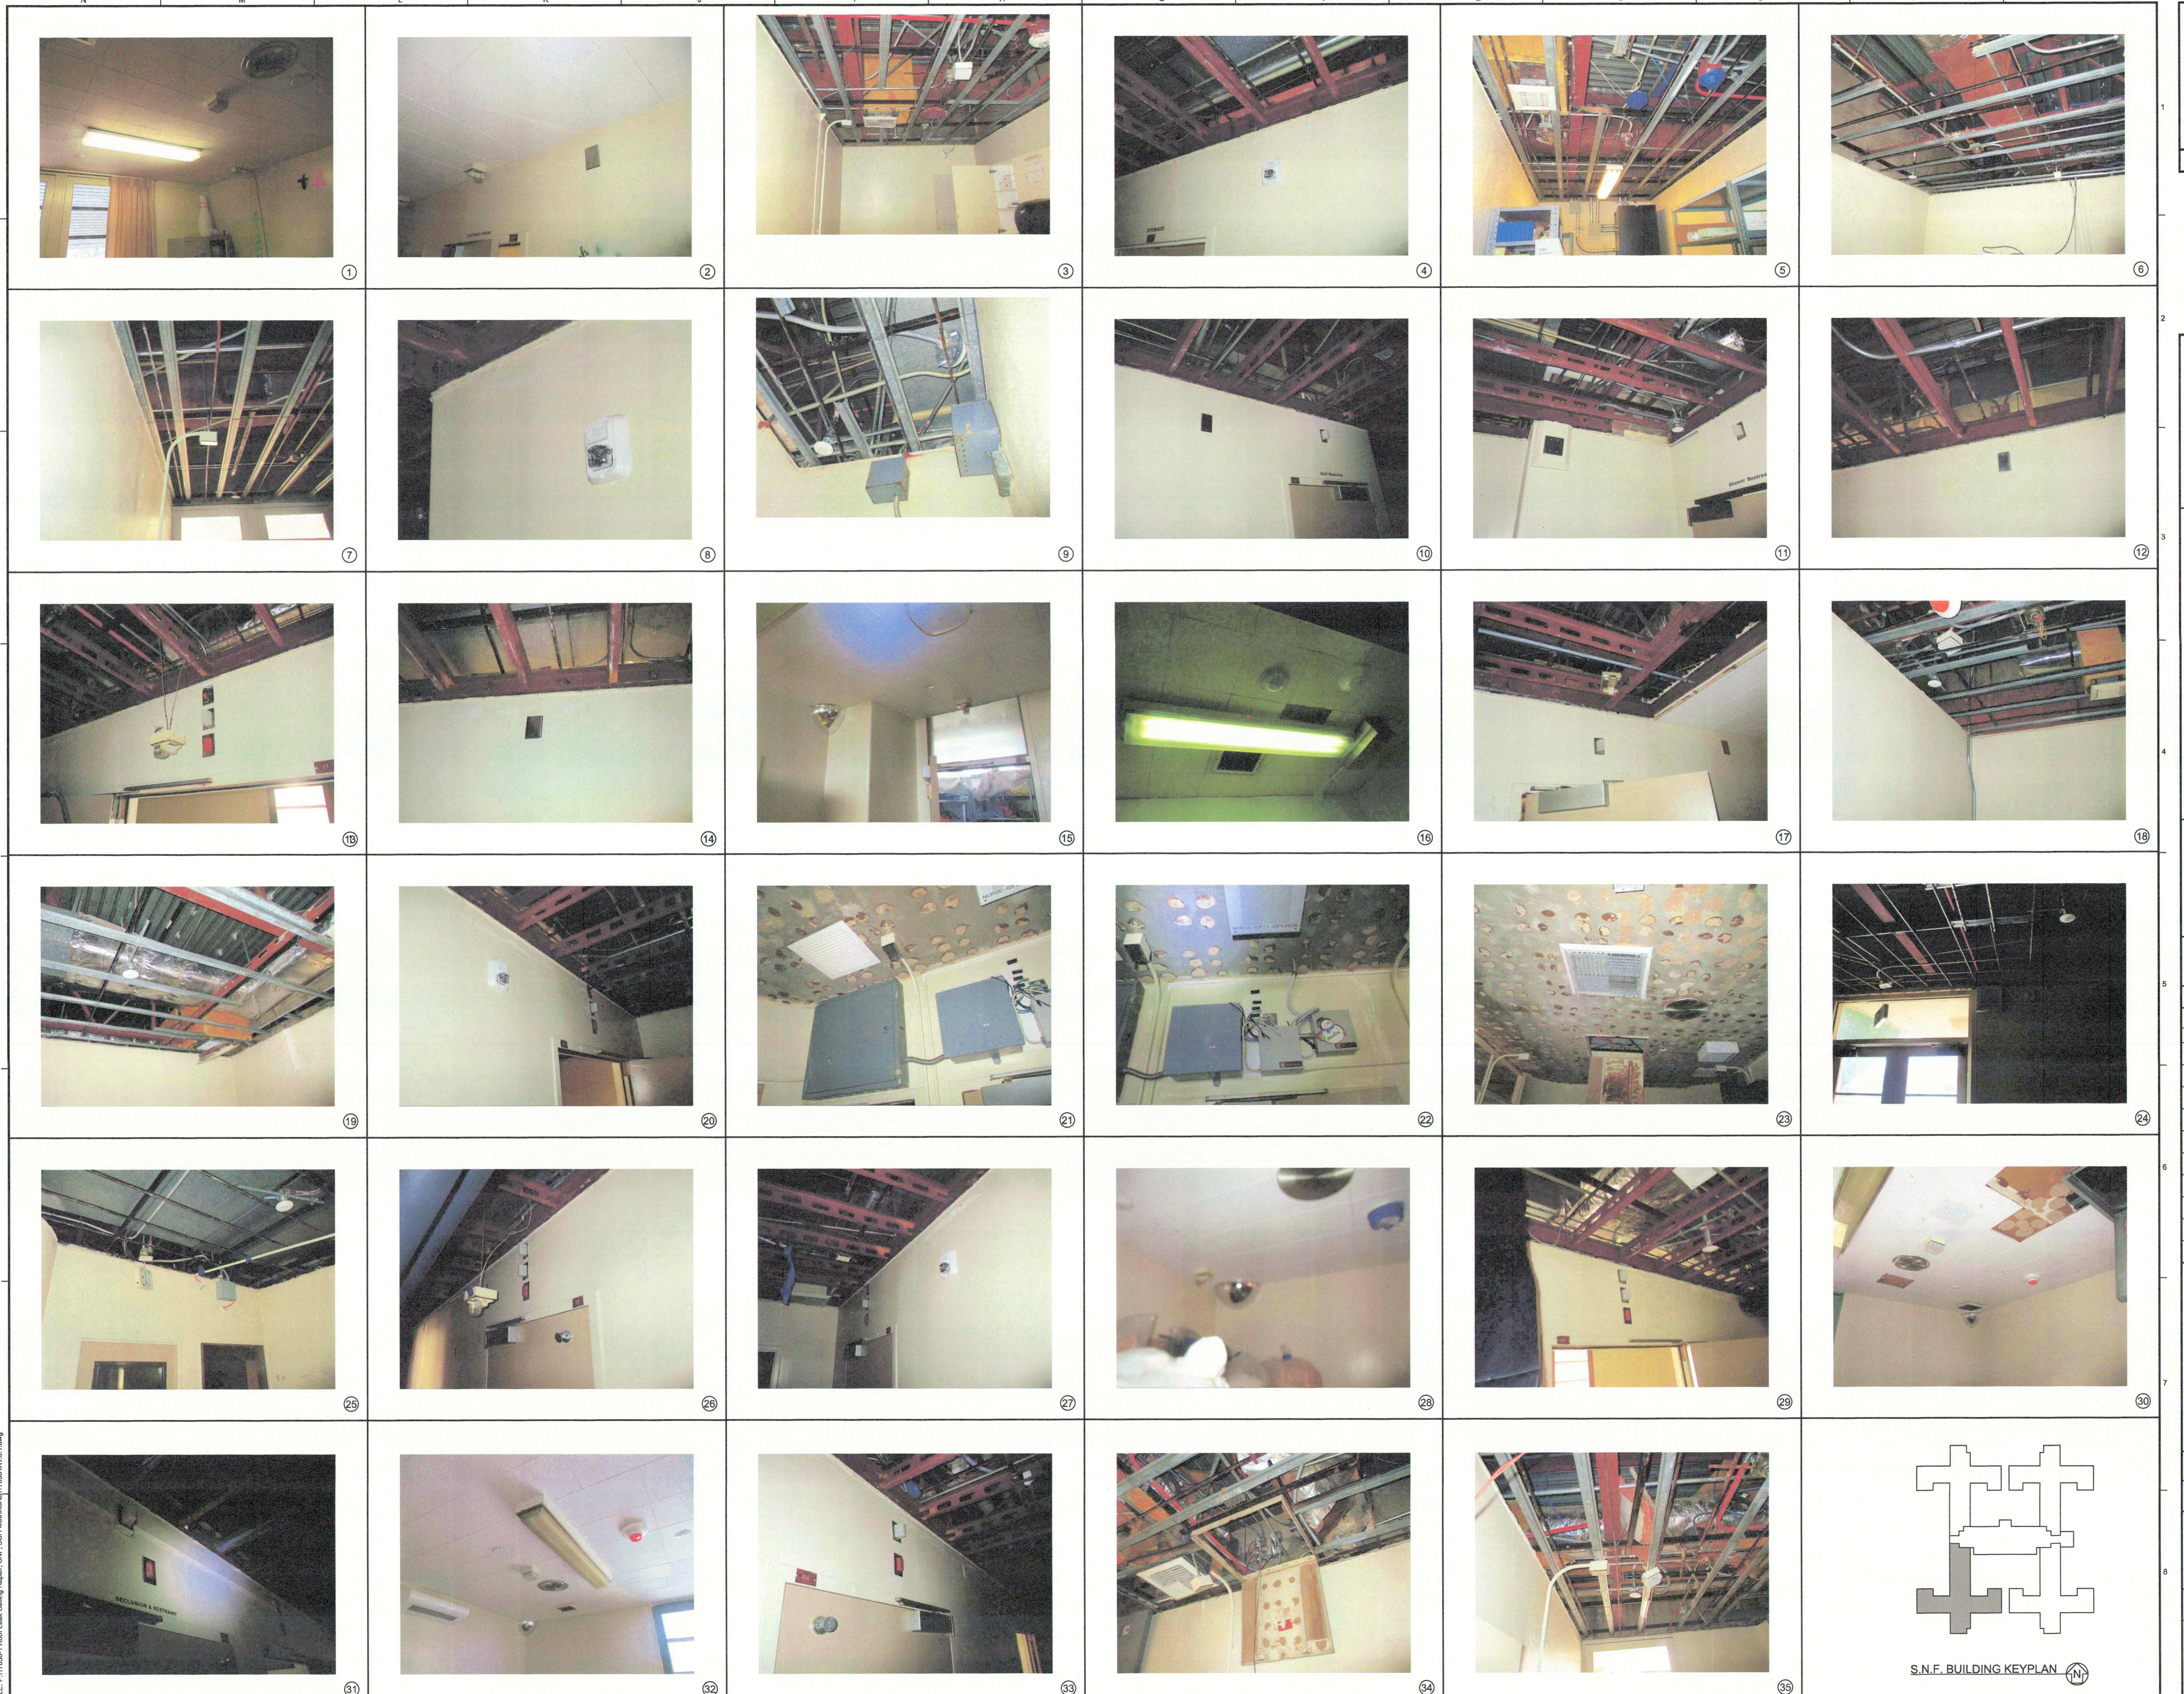

DSA STAMP


State of California
Department of General Services
Real Estate Services Division
DGS
Project Management Branch
707 Third Street, Suite 3-305
Sacramento, California 95605
Project Director:
(916) 445-9618 (Phone)
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approving conditions. Final approval is re-
quired to field inspection. One set of approved plan-
s shall be filed with the State Fire Marshal's Office.

APR 19 2022

OFFICE OF THE STATE FIRE MARSHAL

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Reviewed by 

Jason Charles, DSM III

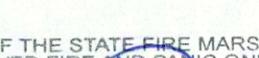

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TORRANCE, CALIFORNIA 90501
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JCCA #17038-1

Issue: 18-S-1084-C-PI

No. Date Description

- 11/01/21 FINAL DRAWINGS V1

- 3/2/22 FINAL DRAWINGS V2

Project
**DSH-METROPOLITAN
SNF BLDG
RE-ROOF LEAK
DAMAGE REPAIR
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11401 Bloomfield Ave.
Norwalk, CA. 90650
Los Angeles County

DGS PROJECT # DGS0000142412C

SFM FAC #19-19-43-0002

Supervisor _____ Drawn _____ Checked _____

V.L. _____ MJK _____

File Date _____ Vault File Number _____

Sheet Title


**UNIT 420 - EXISTING
CONDITIONS
PHOTOGRAPHS**

DSA Building Number _____ Work Order _____

Reference North _____ Sheet Scale _____

AS SHOWN


Sheet Number _____

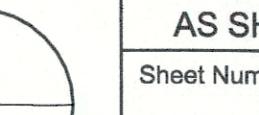

A1.5.1

PHASE 1 CEILING REPAIR - 3/24/22

DSA STAMP

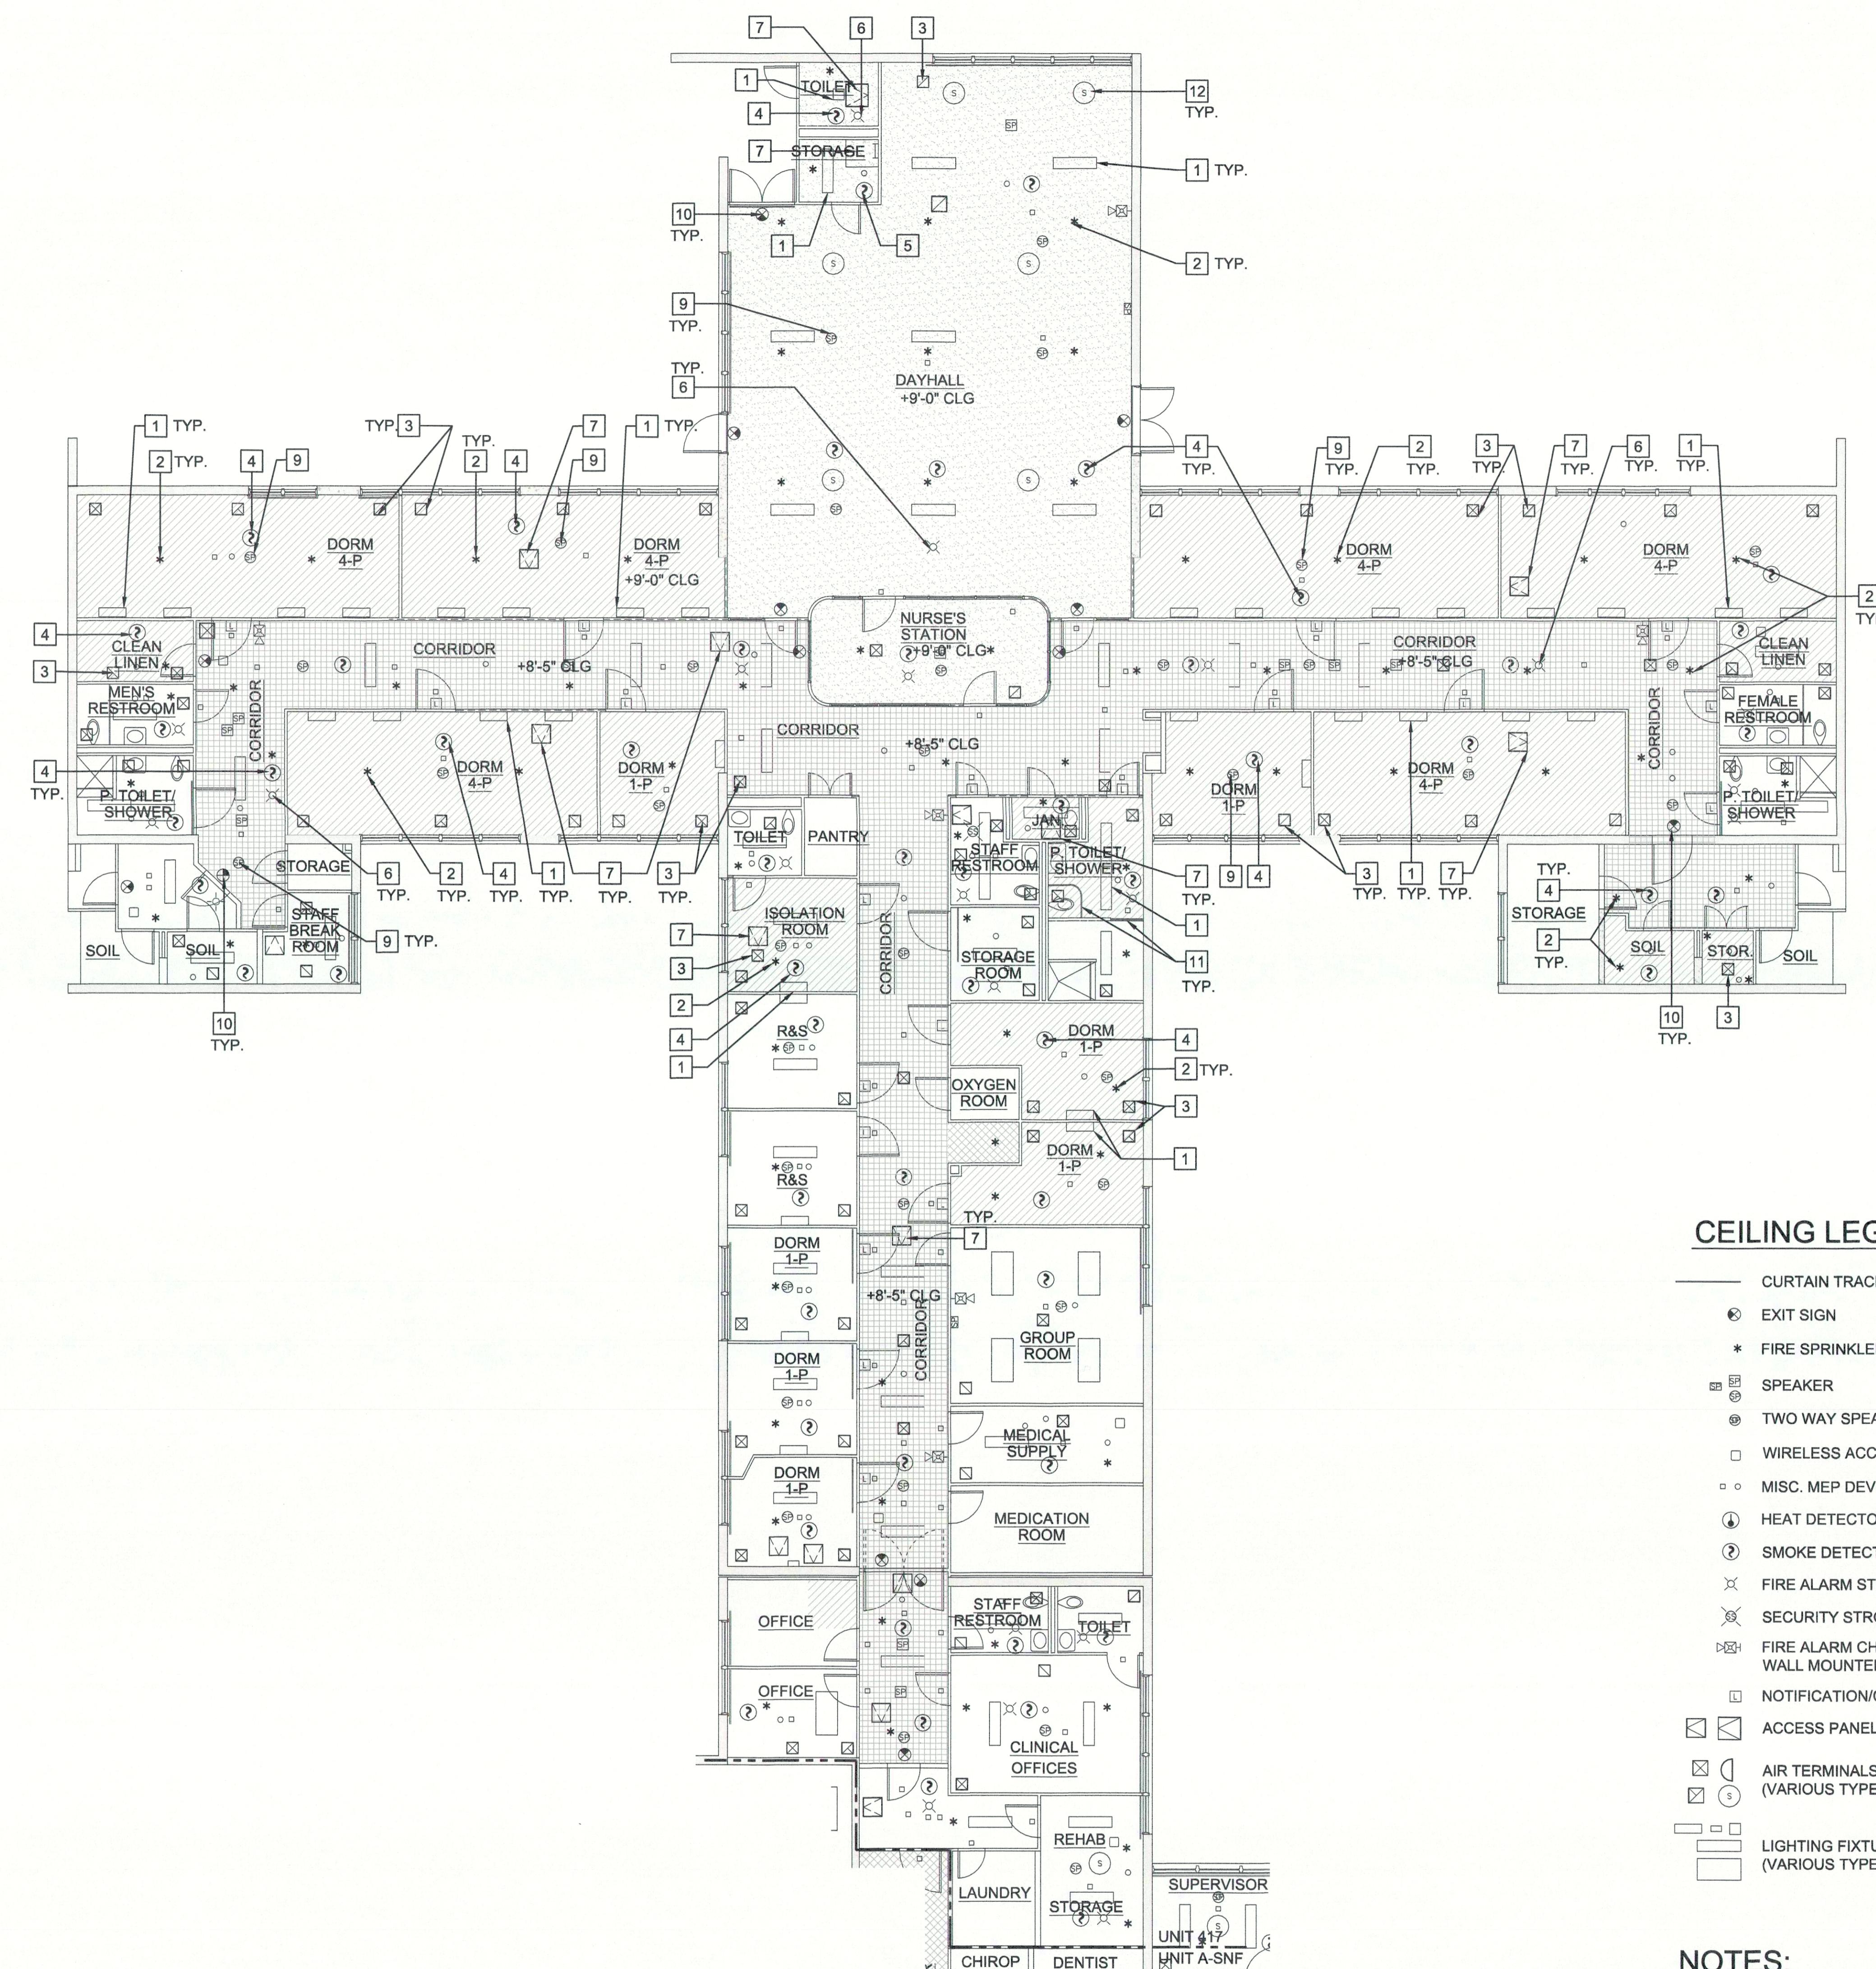

UNIT 417 - CEILING PLAN

SCALE: 0 4 8 FEET 16
1/8" = 1'-0"

NEW WORK KEYNOTES:

- (E) - EXISTING
(N) - NEW
- [1] CEILING MOUNTED LIGHT FIXTURE (N.C.) - (E) CONDUIT AND TERMINATION AT CEILING FINISH TO REMAIN FOR FUTURE LIGHT FIXTURE INSTALLATION. EXTEND CONDUIT WHEN THICKNESS OF CEILING FINISH CHANGED. (3) (5&7) (A3.3)
- [2] (E) FIRE SPRINKLER HEAD - LOWER F.S. HEAD WHEN THICKNESS OF CEILING FINISH CHANGED. REUSE (E) BRACKET TO ATTACH. PROVIDE THE MANUFACTURER'S APPROVED BRACKET WITH FURRING CHANNEL TO (E) CEILING FRAMING. (11) (A3.3)
- [3] (E) AIR SUPPLY & RETURN GRILLE - REMOVE AND REINSTALL. (6&8) (A3.3)
- [4] (E) CEILING MOUNTED SMOKE DETECTOR. REINSTALL AFTER CONSTRUCTION IS FINISHED.
- [5] (E) CEILING MOUNTED HEAT DETECTOR. REINSTALL AFTER CONSTRUCTION IS FINISHED.
- [6] (E) CEILING MOUNTED FIRE ALARM WITH COVER
- [7] (E) CEILING MOUNTED ACCESS DOOR & SUPPORT FRAMING (10) (A3.3)
- [8] NOT USED.
- [9] (E) RECESSED CEILING MOUNT SPEAKER. PROVIDE FIRE RATED HOUSING OR COVER.
- [10] (E) CEILING MOUNT EXIT SIGN - REMOVE AND REINSTALL. EXTEND CONDUIT WHEN THICKNESS OF CEILING FINISH CHANGED.
- [11] (E) CURTAIN TRACK - REMOVE AND REINSTALL AT (E) SUPPORT
- [12] (E) GRILLE FOR EXHAUST FAN. REINSTALL AT (E) SUPPORT.

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Approval of this plan does not authorize or
constitute a permit. Construction shall conform to
applicable regulations. Final approval is subject
to a thorough inspection. A copy of the plan
shall be available on the project site at all times.
APR 19 2022
OFFICE OF THE STATE FIRE MARSHAL
APPROVED FIRE AND P.A.C. ONLY
Reviewed by: [Signature] D.F.M. III

CEILING LEGEND:


- CURTAIN TRACK ON CEILING
- EXIT SIGN
- * FIRE SPRINKLER
- SPEAKER
- Two Way Speaker
- WIRELESS ACCESS POINTS
- MISC. MEP DEVICES
- HEAT DETECTOR
- SMOKE DETECTOR
- FIRE ALARM STROBE
- SECURITY STROBE
- FIRE ALARM CHIME STROBE
WALL MOUNTED
- NOTIFICATION/CALL LIGHT
- ACCESS PANEL
- AIR TERMINALS
(VARIOUS TYPES & SIZE)
- LIGHTING FIXTURES
(VARIOUS TYPES & SIZE)

WALL LEGEND:

- 8" CONCRETE WALL (5) (A3.1)
- 2-1/2" SOLID PLASTER WALL (4A) (4B) (A3.1)
- 4" PLASTER ON METAL STUD

NOTES:

1. PROVIDE FIRESTOP ASSEMBLY AT NEW AND EXISTING PENETRATIONS.
2. PAINT CEILING ACROSS ENTIRE ROOM OR TO NATURAL BREAK POINT.
3. REINSTALL (E) CEILING ACCESS PANELS TO ORIGINAL LOCATION AT EXISTING FRAME. PROVIDE (N) FRAMING AT THE CORRIDOR.
4. ALL CEILING AND WALL-MOUNTED FIXTURES AND CONDUIT 12" FROM THE CEILING IN THE WORK AREA SHALL BE REMOVED, PROTECTED, AND REINSTALLED.
5. WHEN DISCONNECTION OF FIRE PROTECTION SYSTEM AND UTILITY SERVICE IS REQUIRED, INFORM DATE AND PERIOD TO FACILITY MANAGER AND PROJECT ARCHITECT IN ADVANCE.
6. FIELD VERIFY ALL UTILITY AND FIRE PROTECTION SYSTEMS ARE WORKING PROPERLY BEFORE BEGINNING OF PROJECT. NOTIFY THE FACILITY MANAGER AND PROJECT ARCHITECT IF ANY SYSTEM DOES NOT FUNCTION.

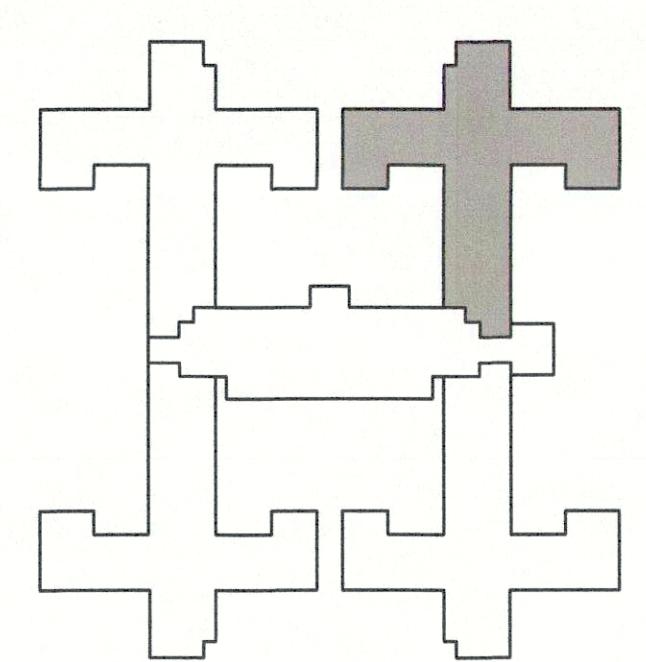

S.N.F. BUILDING KEYPLAN (N)


JCCA J.C. CHANG & ASSOCIATES, INC.
ENGINEERS • ARCHITECTS • PLANNERS
385 VAN NESS AVENUE, SUITE 208
TORRANCE, CALIFORNIA 90509
PH (310) 215-7644
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JCCA #17038-1
Issue: 18-S-1084-C-PI
No. Date Description
- 11/01/21 FINAL DRAWINGS V1
- 3/2/22 FINAL DRAWINGS V2

Project
**DSH-METRPOLITAN
SNF BLDG
RE-ROOF LEAK
DAMAGE REPAIR
PROJECT**
11401 Bloomfield Ave.
Norwalk, CA, 90650
Los Angeles County
DGS PROJECT # DGS00000142412C
SFM FAC #19-19-43-0002

Supervisor	Designed	Drawn	Checked
MJK		V.L.	MJK
File Date	Vault File Number		
Sheet Title			
UNIT 417 CEILING PLAN			
DSA Building Number		Work Order	
Reference North		Sheet Scale	
		AS SHOWN	
		Sheet Number	
		(N)	

A2.1

DSA STAMP

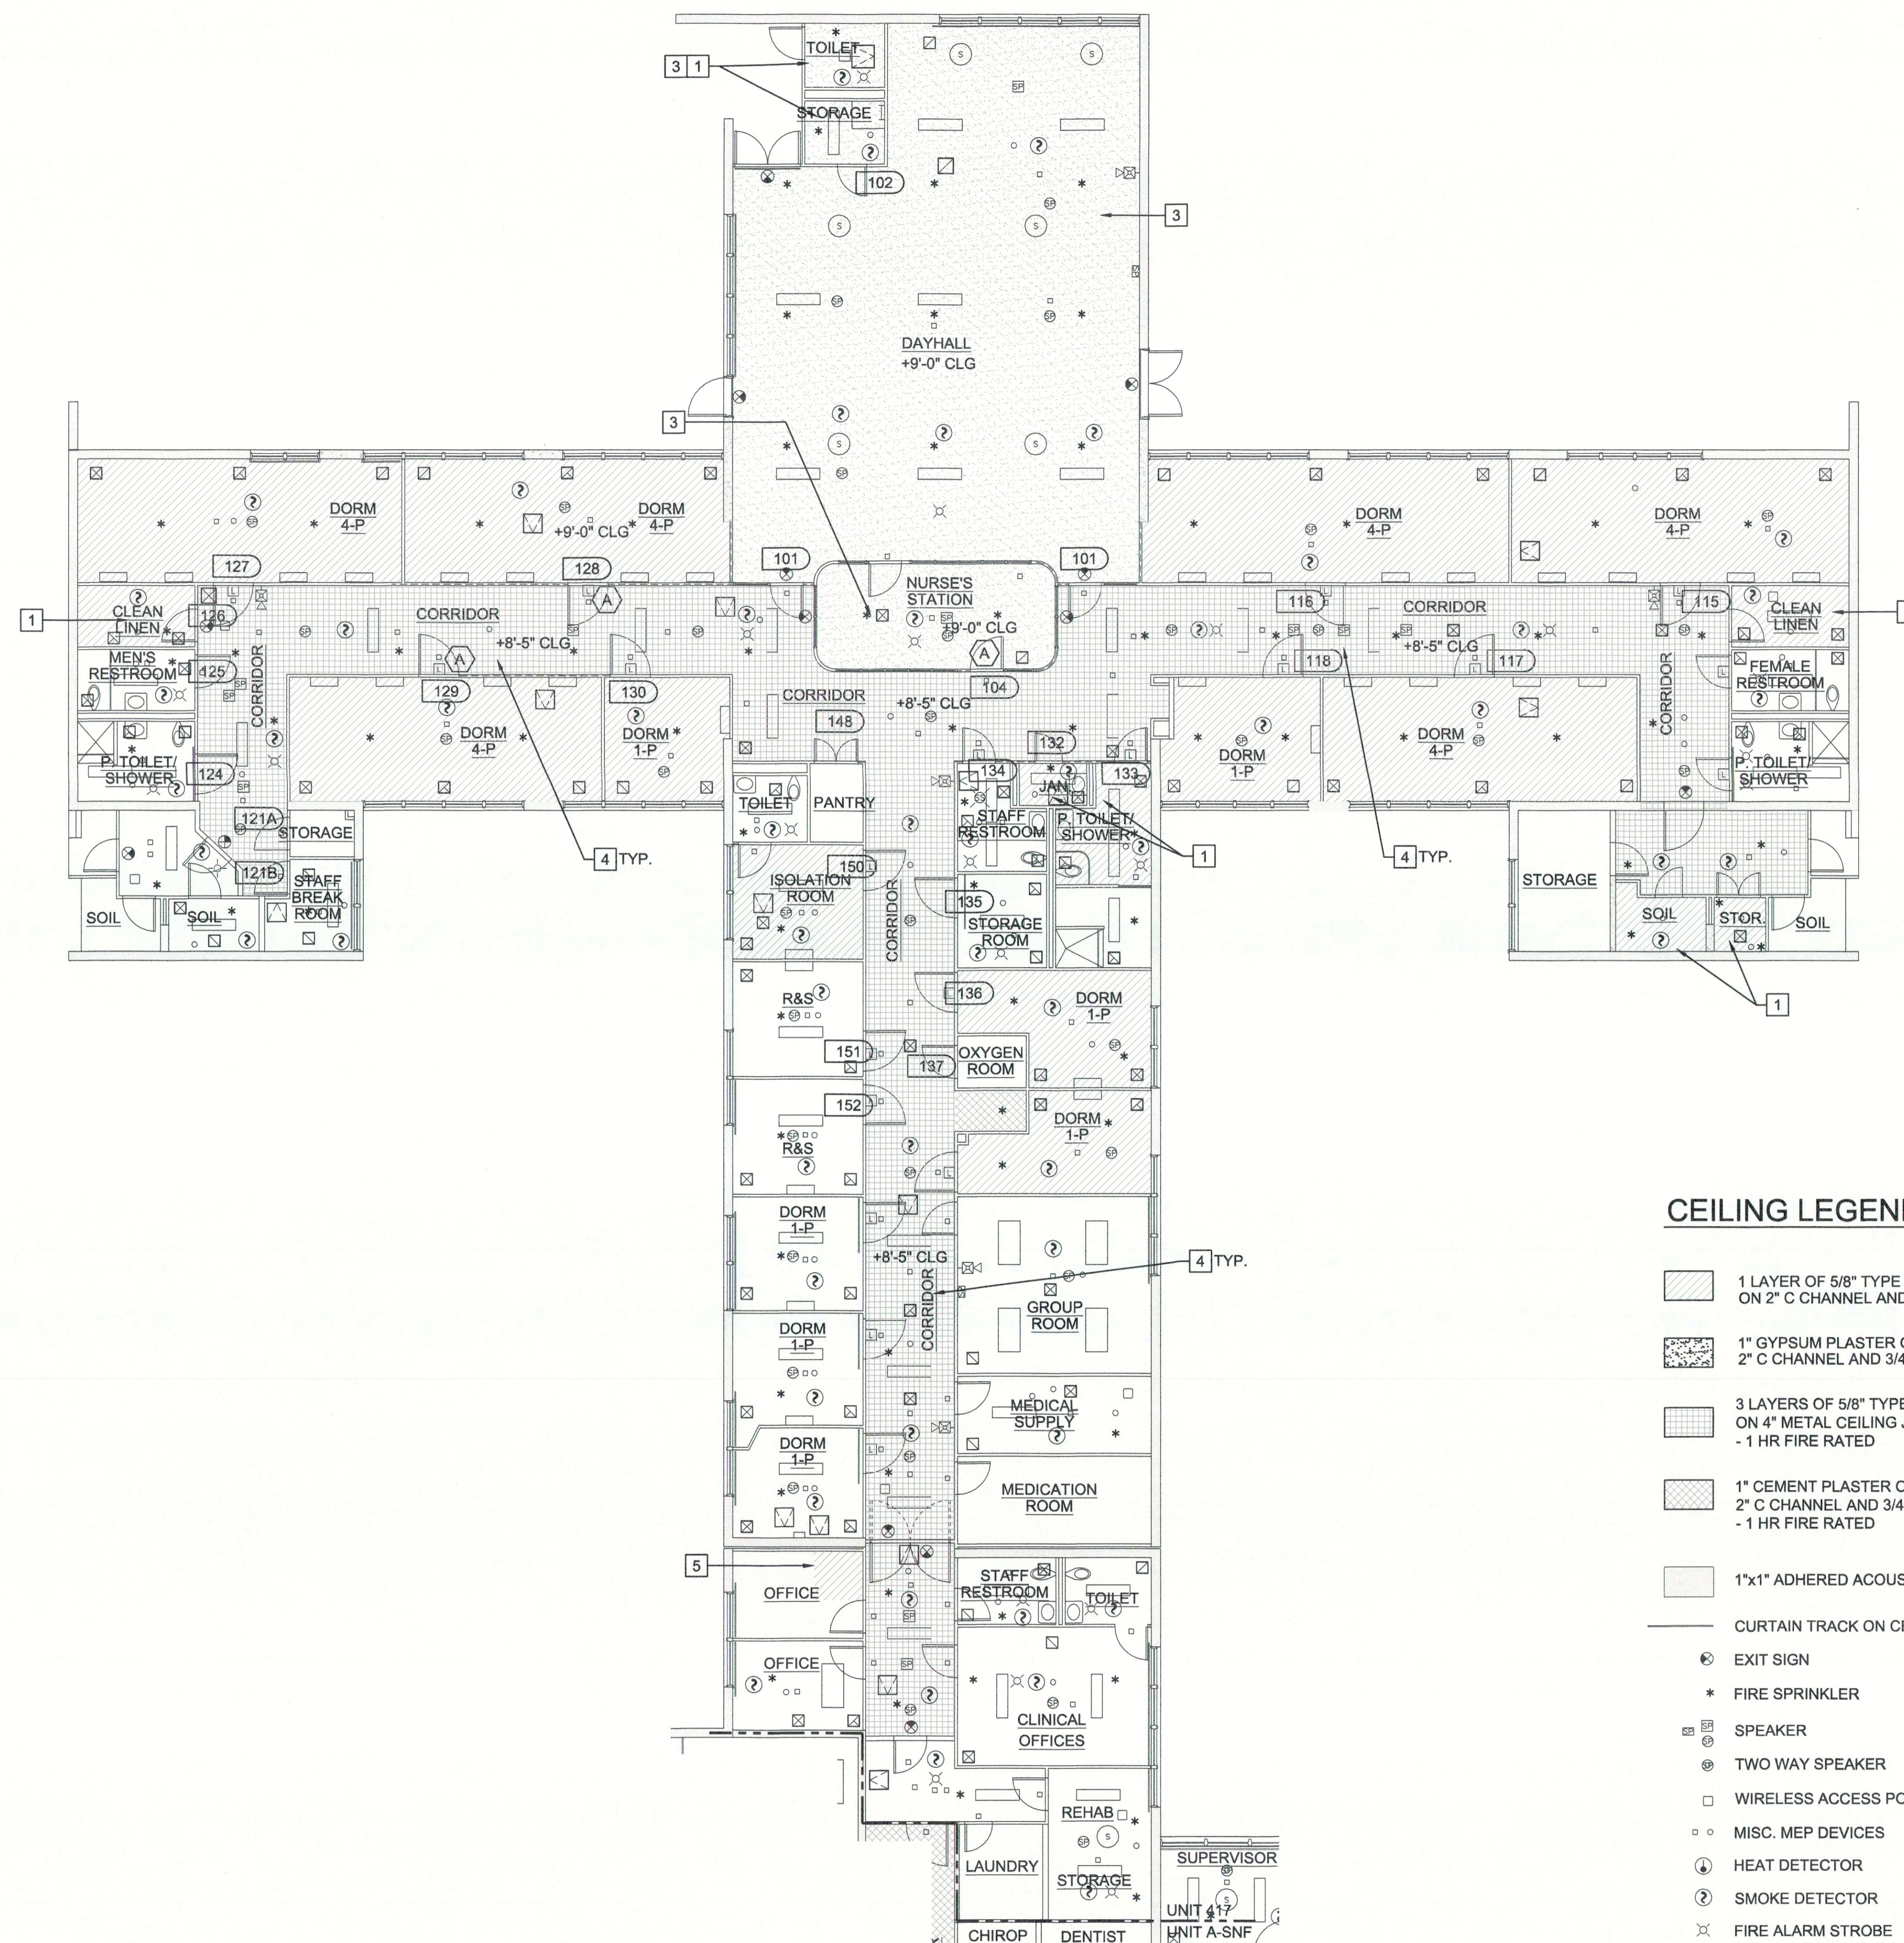

UNIT 417 - CEILING FINISH PLAN

N

NEW WORK KEYNOTES:

- (E) - EXISTING
(N) - NEW
- [1] PAINT CEILING FINISH. PROVIDE PRIMER SUITABLE FOR SUBSTRATE AND MIN. 3 COATS OF PAINT. VOC CONTENT SHALL BE ZERO OR NO MORE THAN 50 G/L. COLOR SELECTED BY FACILITY MANAGER FROM THE MANUFACTURER'S FULL SELECTION.
- [2] NOT USED.
- [3] REMOVE WATER DAMAGED METAL LATH. (E) CEILING SUPPORT TO REMAIN AND PROTECT. PROVIDE PLASTER TO MATCH (E) MATERIAL AND THICKNESS. 2&3 A3.2
- [4] PROVIDE FIRESTOP SEALANT TO ALL PENETRATION. (HILTI CP 606, FS-ONE MAX, OR UL CERTIFIED APPROVED EQUAL)
- [5] SCREW (N) DRYWALL TO CHANNELS ALL SIDES. PROVIDE FRAMING UNDERRAETH IF NEEDED. SEAL JOINTS WITH COMPOUND AND REINFORCED TAPE. LEVEL 5 FOR EXPOSED FINISH. LEVEL 4 OR 3 FOR ACOUSTIC TILE CEILING. 4&5 A3.2

State of California
Department of General Services
Real Estate Services Division

Project Management Branch
707 Third Street, Suite 3-305
Sacramento, California 95805
Project Director:
(916) 445-3838 (voice)
(916) 376-1677 (Fax)
www.dgs.ca.gov

Approval of this plan does not authorize or
approve any omission or deviation from
applicable regulations. Final approval is subject
to final inspection by the State Fire Marshal.
APR 19 2022OFFICE OF THE STATE FIRE MARSHAL
APPROVED FOR CONSTRUCTION ONLY
Reviewed by Jason Walker OSFM III

J.C. CHANG & ASSOCIATES, INC.
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FAX (310) 215-5272

JCCA #17038-1

Issue: 18-S-1084-C-PI

No. Date Description

- 11/01/21 FINAL DRAWINGS V1

- 3/2/22 FINAL DRAWINGS V2

CEILING LEGEND:

- 1 LAYER OF 5/8" TYPE C GYPSUM BOARD ON 2" C CHANNEL AND 7/8" HAT CHANNEL 4&5 A3.2
- 1" GYPSUM PLASTER ON METAL LATH 2&3 2" C CHANNEL AND 3/4" C CHANNEL A3.2
- 3 LAYERS OF 5/8" TYPE X GYPSUM BOARD ON 4" METAL CEILING JOIST - 1 HR FIRE RATED 3A A3.1 3B A3.1
- 1" CEMENT PLASTER ON METAL LATH 2&3 2" C CHANNEL AND 3/4" C CHANNEL - 1 HR FIRE RATED A3.2
- 1"x1" ADHERED ACOUSTIC TILES ON CEILING
- CURTAIN TRACK ON CEILING
- EXIT SIGN
- * FIRE SPRINKLER
- SPEAKER
- TWO WAY SPEAKER
- WIRELESS ACCESS POINTS
- MISC. MEP DEVICES
- HEAT DETECTOR
- SMOKE DETECTOR
- FIRE ALARM STROBE
- SECURITY STROBE
- FIRE ALARM CHIME STROBE WALL MOUNTED
- NOTIFICATION/CALL LIGHT
- ACCESS PANEL
- AIR TERMINALS (VARIOUS TYPES & SIZE)
- LIGHTING FIXTURES (VARIOUS TYPES & SIZE)


WALL LEGEND:

- 8" CONCRETE WALL 5 A3.1
- 2-1/2" SOLID PLASTER WALL 4A A3.1 4B A3.1
- 4" PLASTER ON METAL STUD

DOOR LEGEND:

SEE 6/A3.1 FOR DOOR TYPES

(A) DOOR TYPE

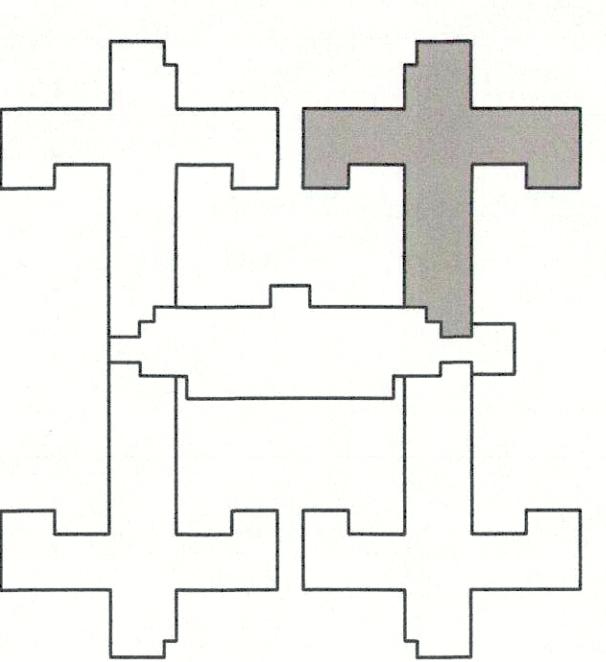

S.N.F. BUILDING KEYPLAN A2.1.1

Project
DSH-METRPOLITAN
SNF BLDG
RE-ROOF LEAK
DAMAGE REPAIR
PROJECT

11401 Bloomfield Ave.
Norwalk, CA. 90650
Los Angeles County
DGS PROJECT # DGS00000142412C
SFM FAC #19-19-43-0002

Supervisor

Designed

Drawn

Checked

V.L.

File Date

Vault File Number

Sheet Title

UNIT 417
CEILING FINISH PLAN

DSA Building Number

Work Order

Reference North


Sheet Scale

AS SHOWN

Sheet Number

A2.1.1

PHASE 1 CEILING REPAIR - 3/24/22

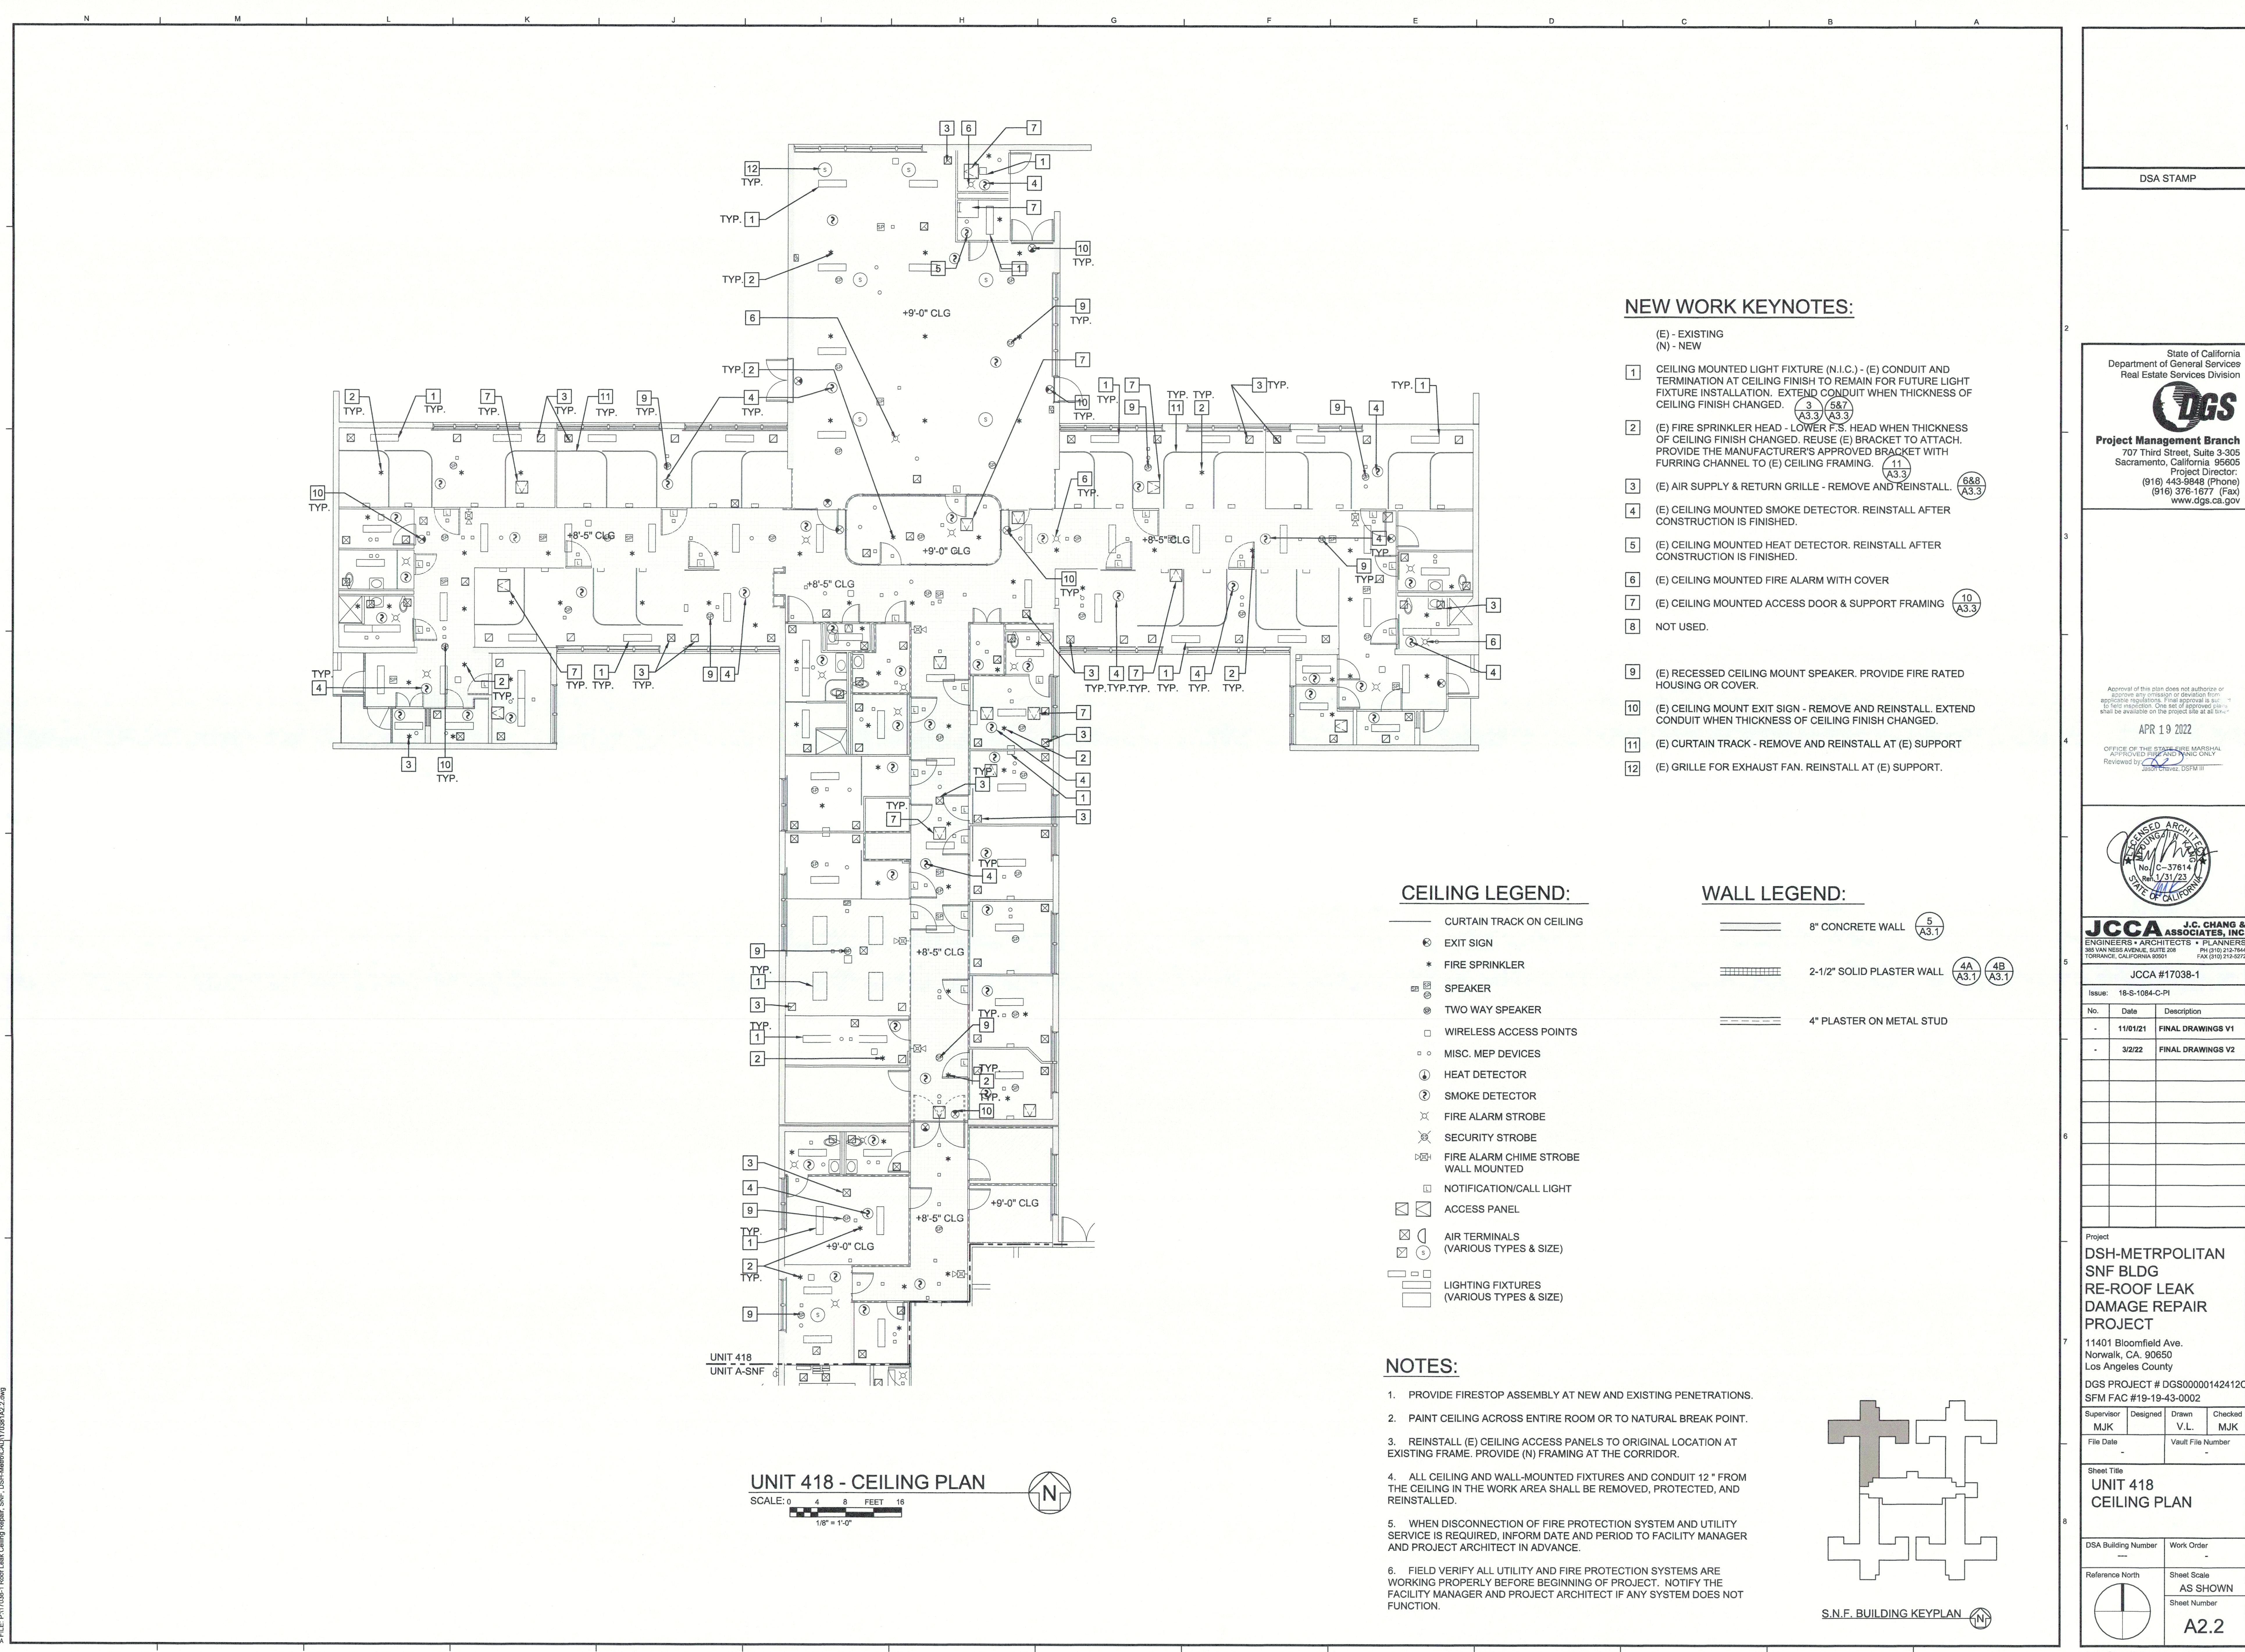

The figure displays an architectural floor plan of a building section, likely a corridor or lobby area. The plan includes various rooms, doorways, and structural elements. Key features include a central entrance, multiple offices, and a large open space. Construction details are indicated throughout the plan, such as ceiling heights (+9'-0" CLG, +8'-5" CLG, +9'-0" GLG), soffit types (SOFFIT. 11 A3.3), and firestop requirements for penetrations. Keynotes are numbered 1 through 5, corresponding to specific instructions in the 'NEW WORK KEYNOTES' section.

NEW WORK KEYNOTES:

(E) - EXISTING
(N) - NEW

- [1] PAINT CEILING FINISH. PROVIDE PRIMER SUITABLE FOR SUBSTRATE AND MIN. 3 COATS OF PAINT. VOC CONTENT SHALL BE ZERO OR NO MORE THAN 50 G/L. COLOR SELECTED BY FACILITY MANAGER FROM THE MANUFACTURER'S FULL SELECTION.
- [2] SOFFIT. 11 A3.3
- [3] REMOVE WATER DAMAGED METAL LATH. (E) CEILING SUPPORT TO REMAIN AND PROTECT. PROVIDE PLASTER TO MATCH (E) MATERIAL AND THICKNESS. 2&3 A3.2
- [4] PROVIDE FIRESTOP SEALANT TO ALL PENETRATION. (HILTI CP 606, FS-ONE MAX, OR UL CERTIFIED APPROVED EQUAL)
- [5] SCREW (N) DRYWALL TO CHANNELS ALL SIDES. PROVIDE FRAMING UNDERNEATH IF NEEDED. SEAL JOINTS WITH COMPOUND AND REINFORCED TAPE. LEVEL 5 FOR EXPOSED FINISH. LEVEL 4 OR 3 FOR ACOUSTIC TILE CEILING. 4&5 A3.2

DSA STAMP

Project Management
707 Third Street, S
Sacramento, California
Project
(916) 443-9844
(916) 376-1234
www.ca.gov

Approval of this plan does not constitute an endorsement by the State of California or its agencies. Final approval is subject to field inspection. One set of approved plans shall be available on the project site.

APR 19 2022

OFFICE OF THE STATE FIRE MARSHAL
APPROVED FOR AUTOMATIC
Reviewed by: Jason Chavez, DSFM

This architectural floor plan provides a detailed layout of Unit 418, specifically the A-SNF section. The plan includes multiple levels and various rooms, each with specific ceiling and door types indicated by callouts and legends.

CEILING LEGEND:

- 1 LAYER OF 5/8" GYP. ON 2" C CHANNEL
- 1" GYPSUM PLATE ON 2" C CHANNEL
- 3 LAYERS OF 5/8" GYP. ON 4" METAL CH.
- 1" CEMENT PLATE ON 2" C CHANNEL
- 1"x1" ADHERED
- CURTAIN TRACK

DOOR LEGEND:

SEE 6/A3.2 FOR DOOR TYPES

- (A) DOOR TYPE
- (B) DOOR TYPE
- (D) DOOR TYPE
- (F) DOOR TYPE

1B A3.1

UNIT 418
UNIT A-SNF

Callouts point to specific areas for detailed views:

- Top Callout: Shows a corridor with ceiling type +9'-0" CLG and door type 3 TYP.
- Middle Left Callout: Shows a room with ceiling type +8'-5" CLG and door type 4 TYP.
- Middle Right Callout: Shows a room with ceiling type +8'-5" CLG and door type 5 TYP.
- Bottom Callout: Shows a room with ceiling type +9'-0" CLG and door type 5 TYP.

The plan also includes numerous symbols representing building systems and features:

- Exit signs
- Fire sprinklers
- Speakers
- Two-way speakers
- Wireless access points
- Miscellaneous MEP devices
- Heat detectors
- Smoke detectors
- Fire alarm systems

UNIT 418 - CEILING FINISH PLAN

SCALE: 0 4 8 FEET 1

1/8" = 1'-0"







DOOR LEGEND:

SEE 6/A3.2 FOR DOOR TYPES


-  DOOR TYPE
 -  DOOR TYPE
 -  DOOR TYPE
 -  DOOR TYPE

CEILING LEGEND:

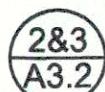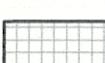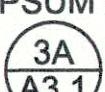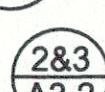- | | | | |
|---|---|--|---|
|  | 1 LAYER OF 5/8" TYPE C GYPSUM BOARD
ON 2" C CHANNEL AND 7/8" HAT CHANNEL | 
4&5
A3.2 | |
|  | 1" GYPSUM PLASTER ON METAL LATH
2" C CHANNEL AND 3/4" C CHANNEL | 
2&3
A3.2 | |
|  | 3 LAYERS OF 5/8" TYPE 'X' GYPSUM BOARD
ON 4" METAL CEILING JOIST | 
3A
A3.1 | 
3B
A3.1 |
|  | 1" CEMENT PLASTER ON METAL LATH
2" C CHANNEL AND 3/4" C CHANNEL | 
2&3
A3.2 | |
|  | 1" ADHERED ACOUSTIC TILES ON CEILING | | |

WALL LEGEND:

- | | | |
|--|---------------------------|--|
| | 8" CONCRETE WALL | |
| | 2-1/2" SOLID PLASTER WALL | |
| | 4" PLASTER ON METAL STUD | |

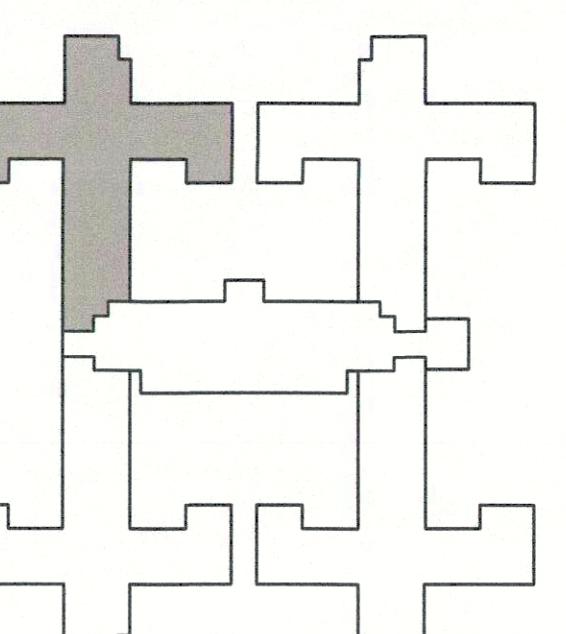

S.N.F. BUILDING KEYPLAN

State of California
Department of General Services
Real Estate Services Division

Approval of this plan does not authorize or approve any omission or deviation from applicable regulations. Final approval is subject to field inspection. One set of approved plans shall be available on the project site at all times.

APR 19 2022

OFFICE OF THE STATE FIRE MARSHAL
APPROVED FIRE AND PANIC ONLY
Reviewed by:  DCFM-HL

JCCA J.C. CHANG &
ASSOCIATES, INC.
ENGINEERS • ARCHITECTS • PLANNERS
385 VAN NESS AVENUE, SUITE 208
TORRANCE, CALIFORNIA 90501
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Project
DSH-METRPOLITAN
SNF BLDG
RE-ROOF LEAK
DAMAGE REPAIR
PROJECT

PROJECT
11401 Bloomfield Ave.
Norwalk, CA. 90650
Los Angeles County

DGS PROJECT # DGS00000142412C
SFM FAC #19-19-43-0002

Supervisor	Designed	Drawn	Checked
MJK		V.L.	MJK

File Date	Vault File Number
-----------	-------------------

Sheet Title

UNIT 418

CEILING FINISH PLAN

CEILING FINISH PLAN

DSA Building Number	Work Order
-----	-

Reference North

Sheet Scale
AS SHOWN
Sheet Number
A-2-1

A2.2.1

SA STAMP



State of California
Department of General Services
Real Estate Services Division

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mission or deviation from
ions. Final approval is subject
n. One set of approved plan
on the project site at all times.

APR 19 2022
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Reviewed by:



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EL SEGUNDO, CALIFORNIA 90501
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FAX (310) 212-5272

JCCA #17038-1

**SH-METRPOLITAN
NF BLDG
E-ROOF LEAK
AMAGE REPAIR
PROJECT**

401 Bloomfield Ave.
Cerritos, CA. 90650
Los Angeles County
PROJECT # DGS00000142412C
MEAC #10-12-43-0002

ervisor IJK	Designed	Drawn V.L.	Checked MJK
Date	Vault File Number		

Sheet Title

UNIT A SNF


TEACHING PLAN

CEILING PLAN

Reference North	Sheet Scale AS SHOWN
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Sheet Number
A2.3

ASE 1 CEILING REPAIR - 3/24/22

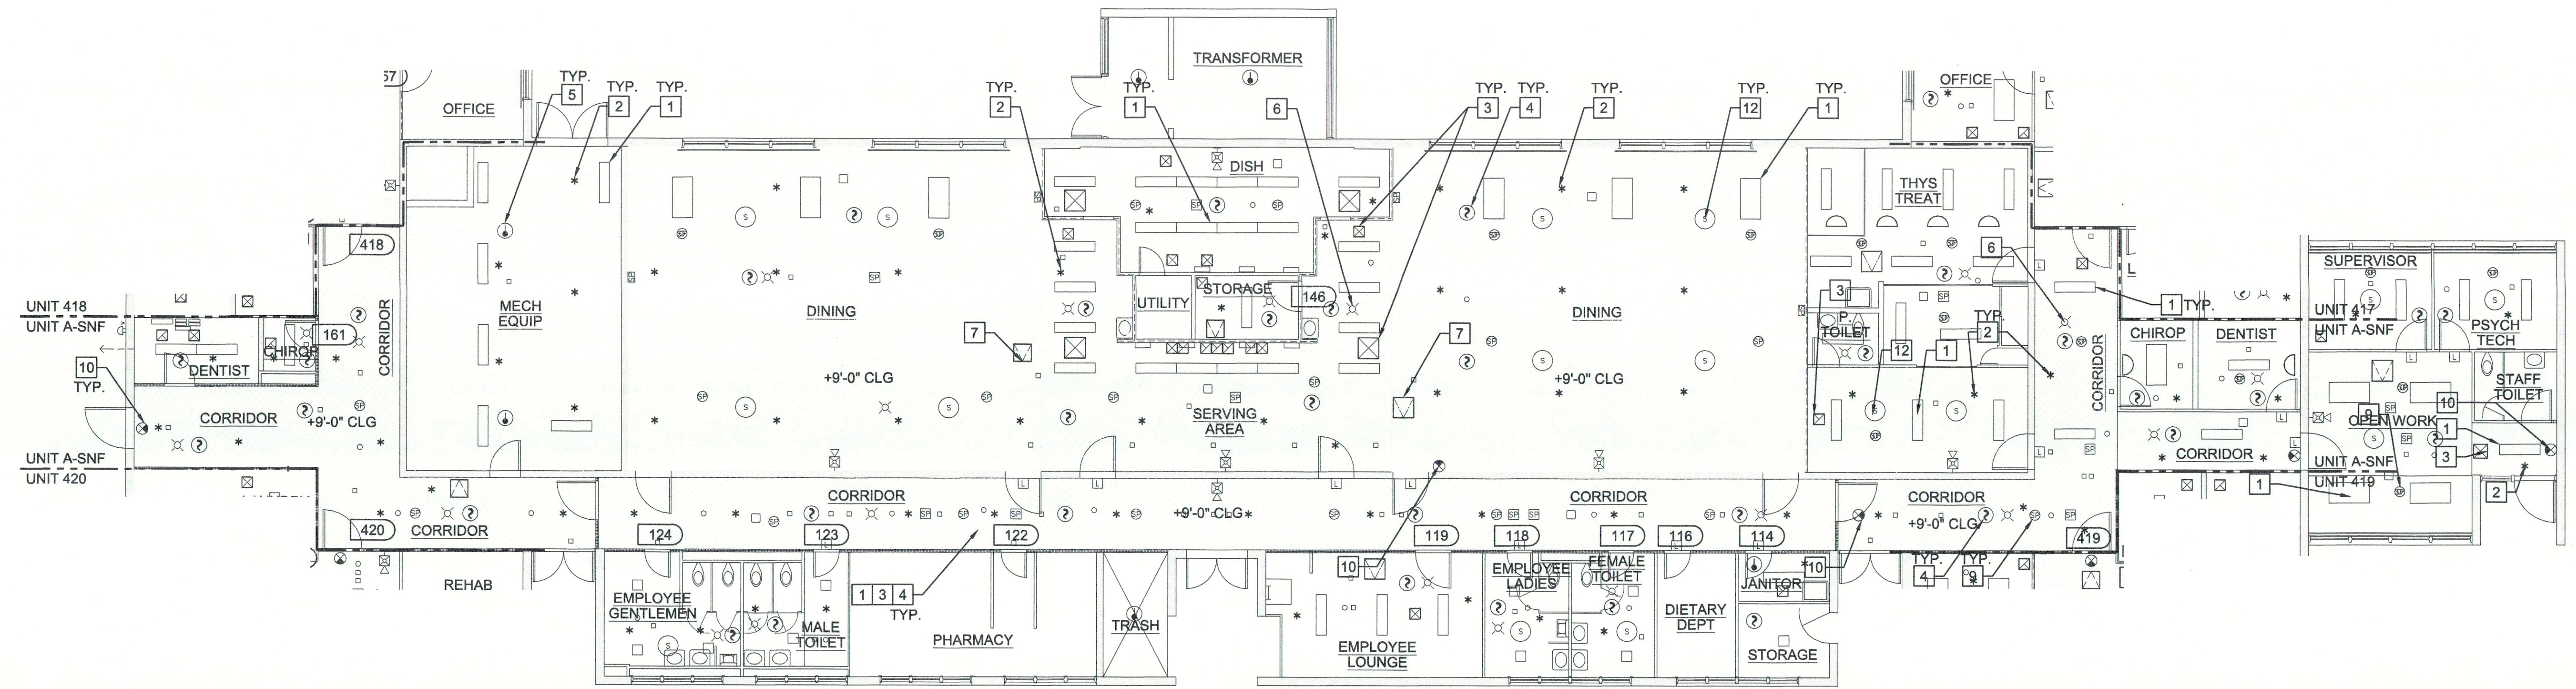


UNIT A SNF - CEILING PLAN

CEILING LEGEND:

- CURTAIN TRACK ON CEILIN


 -  EXIT SIGN
 - * FIRE SPRINKLER
 -   SPEAKER
 -  TWO WAY SPEAKER
 - WIRELESS ACCESS POINTS
 - MISC. MEP DEVICES
 -  HEAT DETECTOR
 -  SMOKE DETECTOR
 -  FIRE ALARM STROBE
 -  SECURITY STROBE
 -  FIRE ALARM CHIME STROBE
WALL MOUNTED
 - NOTIFICATION/CALL LIGHT
 -   ACCESS PANEL
 -   AIR TERMINALS
(VARIOUS TYPES & SIZE)
 -   LIGHTING FIXTURES
(VARIOUS TYPES & SIZE)

WALL LEGEND:

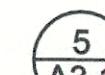- | | | |
|---|---------------------------|---|
|  | 8" CONCRETE WALL |  |
|  | 2-1/2" SOLID PLASTER WALL |   |
|  | 4" PLASTER ON METAL STUD | |


NEW WORK KEYNOTES

- (E) - EXISTING
(N) - NEW

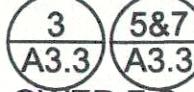 - 1 CEILING MOUNTED LIGHT FIXTURE (N.I.C.) - (E) CONDUIT AND TERMINATION AT CEILING FINISH TO REMAIN FOR FUTURE LIGHT FIXTURE INSTALLATION. EXTEND CONDUIT WHEN THICKNESS OF CEILING FINISH CHANGED. 
 - 2 (E) FIRE SPRINKLER HEAD - LOWER F.S. HEAD WHEN THICKNESS OF CEILING FINISH CHANGED. REUSE (E) BRACKET TO ATTACH. PROVIDE THE MANUFACTURER'S APPROVED BRACKET WITH FURRING CHANNEL TO (E) CEILING FRAMING. 
 - 3 (E) AIR SUPPLY & RETURN GRILLE - REMOVE AND REINSTALL. 
 - 4 (E) CEILING MOUNTED SMOKE DETECTOR. REINSTALL AFTER CONSTRUCTION IS FINISHED.
 - 5 (E) CEILING MOUNTED HEAT DETECTOR. REINSTALL AFTER CONSTRUCTION IS FINISHED.
 - 6 (E) CEILING MOUNTED FIRE ALARM WITH COVER
 - 7 (E) CEILING MOUNTED ACCESS DOOR & SUPPORT FRAMING 
 - 8 NOT USED.
 - 9 (E) RECESSED CEILING MOUNT SPEAKER. PROVIDE FIRE RATED HOUSING OR COVER.
 - 10 (E) CEILING MOUNT EXIT SIGN - REMOVE AND REINSTALL. EXTEND CONDUIT WHEN THICKNESS OF CEILING FINISH CHANGED.
 - 11 (E) CURTAIN TRACK - REMOVE AND REINSTALL AT (E) SUPPORT
 - 12 (E) GRILLE FOR EXHAUST FAN. REINSTALL AT (E) SUPPORT.

NOTES.

1. PROVIDE FIRESTOP ASSEMBLY AT NEW AND EXISTING PENETRATIONS.
 2. PAINT CEILING ACROSS ENTIRE ROOM OR TO NATURAL BREAK POINT.
 3. REINSTALL (E) CEILING ACCESS PANELS TO ORIGINAL LOCATION AT EXISTING FRAME. PROVIDE (N) FRAMING AT THE CORRIDOR.
 4. ALL CEILING AND WALL-MOUNTED FIXTURES AND CONDUIT 12 " FROM THE CEILING IN THE WORK AREA SHALL BE REMOVED, PROTECTED, AND REINSTALLED.
 5. WHEN DISCONNECTION OF FIRE PROTECTION SYSTEM AND UTILITY SERVICE IS REQUIRED, INFORM DATE AND PERIOD TO FACILITY MANAGER AND PROJECT ARCHITECT IN ADVANCE.
 6. FIELD VERIFY ALL UTILITY AND FIRE PROTECTION SYSTEMS ARE WORKING PROPERLY BEFORE BEGINNING OF PROJECT. NOTIFY THE FACILITY MANAGER AND PROJECT ARCHITECT IF ANY SYSTEM DOES NOT

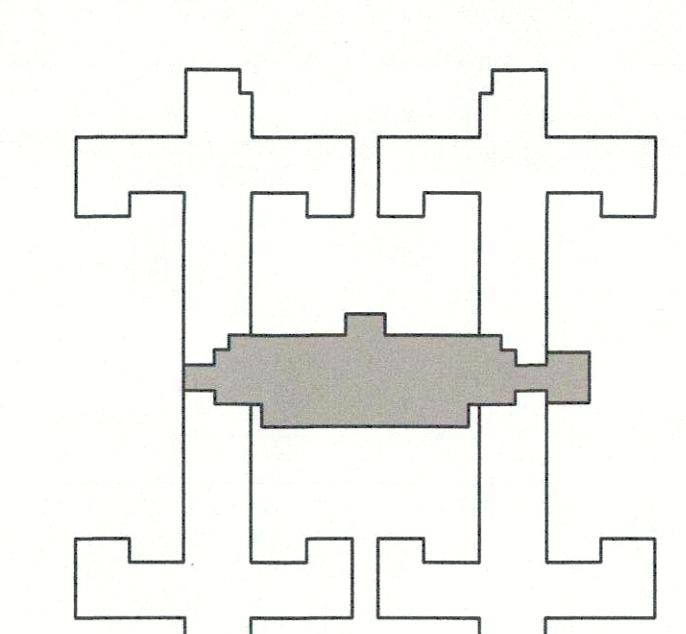

S.N.E. BUILDING KEYPLAN

NEW WORK KEYNOTES:

(E) - EXISTING
(N) - NEW

- 1 PAINT CEILING FINISH. PROVIDE PRIMER SUITABLE FOR SUBSTRATE AND MIN. 3 COATS OF PAINT. VOC CONTENT SHALL BE ZERO OR NO MORE THAN 50 G/L. COLOR SELECTED BY FACILITY MANAGER FROM THE MANUFACTURER'S FULL SELECTION.
- 2 PATCH PLASTER. FIND A NATURAL BREAK POINT FOR JOINT. ¹_{A3.3}
- 3 REMOVE WATER DAMAGED METAL LATH. (E) CEILING SUPPORT TO REMAIN AND PROTECT. PROVIDE PLASTER TO MATCH (E) MATERIAL AND THICKNESS. ²⁸³_{A3.2}
- 4 PROVIDE FIRESTOP SEALANT TO ALL PENETRATION. (HILTI CP 606, FS-ONE MAX, OR UL CERTIFIED APPROVED EQUAL)
- 5 SCREW (N) DRYWALL TO CHANNELS ALL SIDES. PROVIDE FRAMING UNDERNEATH IF NEEDED. SEAL JOINTS WITH COMPOUND AND REINFORCED TAPE. LEVEL 5 FOR EXPOSED FINISH. LEVEL 4 OR 3 FOR ACOUSTIC TILE CEILING. ⁴⁸⁵_{A3.2}
- 6 CEILING FINISH TRANSITION. PROVIDE APPROPRIATE METAL TRIM FOR FINISHES. APPLY FOOD GRADE SEALANT. ²_{A3.3}

DSA STAMP

State of California
Department of General Services
Real Estate Services Division



Project Management Branch
707 Third Street, Suite 3-305
Sacramento, California 95605
Project Director:
(916) 449-9848 (Phone)
(916) 376-1677 (Fax)
www.dgs.ca.gov

Approval of this plan does not authorize or
imply that the design or construction
thereof complies with all applicable
regulations. Final approval is subject
to a review by the State Fire Marshal's Office.
That office shall be available on the project site at all times.

APR 19 2022

OFFICE OF THE STATE FIRE MARSHAL
APPROVED BY THE STATE FIRE MARSHAL
Reviewed by:
J. Chang, PE, USPFI III



J.C. CHANG & ASSOCIATES, INC.
ENGINEERS • ARCHITECTS • PLANNERS
385 VAN NESS AVENUE, SUITE 208
TORRANCE, CALIFORNIA 90501
FAX (310) 212-5772

JCCA #17038-1

Issue: 18-S-1084-C-PI
No. Date Description
- 11/01/21 FINAL DRAWINGS V1
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Project
DSH-METRPOLITAN
SNF BLDG
RE-ROOF LEAK
DAMAGE REPAIR
PROJECT


11401 Bloomfield Ave.
Norwalk, CA. 90650
Los Angeles County

DGS PROJECT # DGS0000142412C
SFM FAC #19-19-43-0002

Supervisor _____ Drawn _____ Drawn V.L. _____ Checked V.L. _____
File Date _____ Vault File Number _____


Sheet Title
UNIT A SNF
CEILING FINISH PLAN

DSA Building Number _____ Work Order _____
Reference North _____ Sheet Scale _____ AS SHOWN
Sheet Number _____

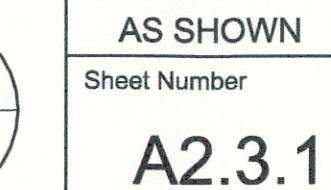

A2.3.1

PHASE 1 CEILING REPAIR - 3/24/22

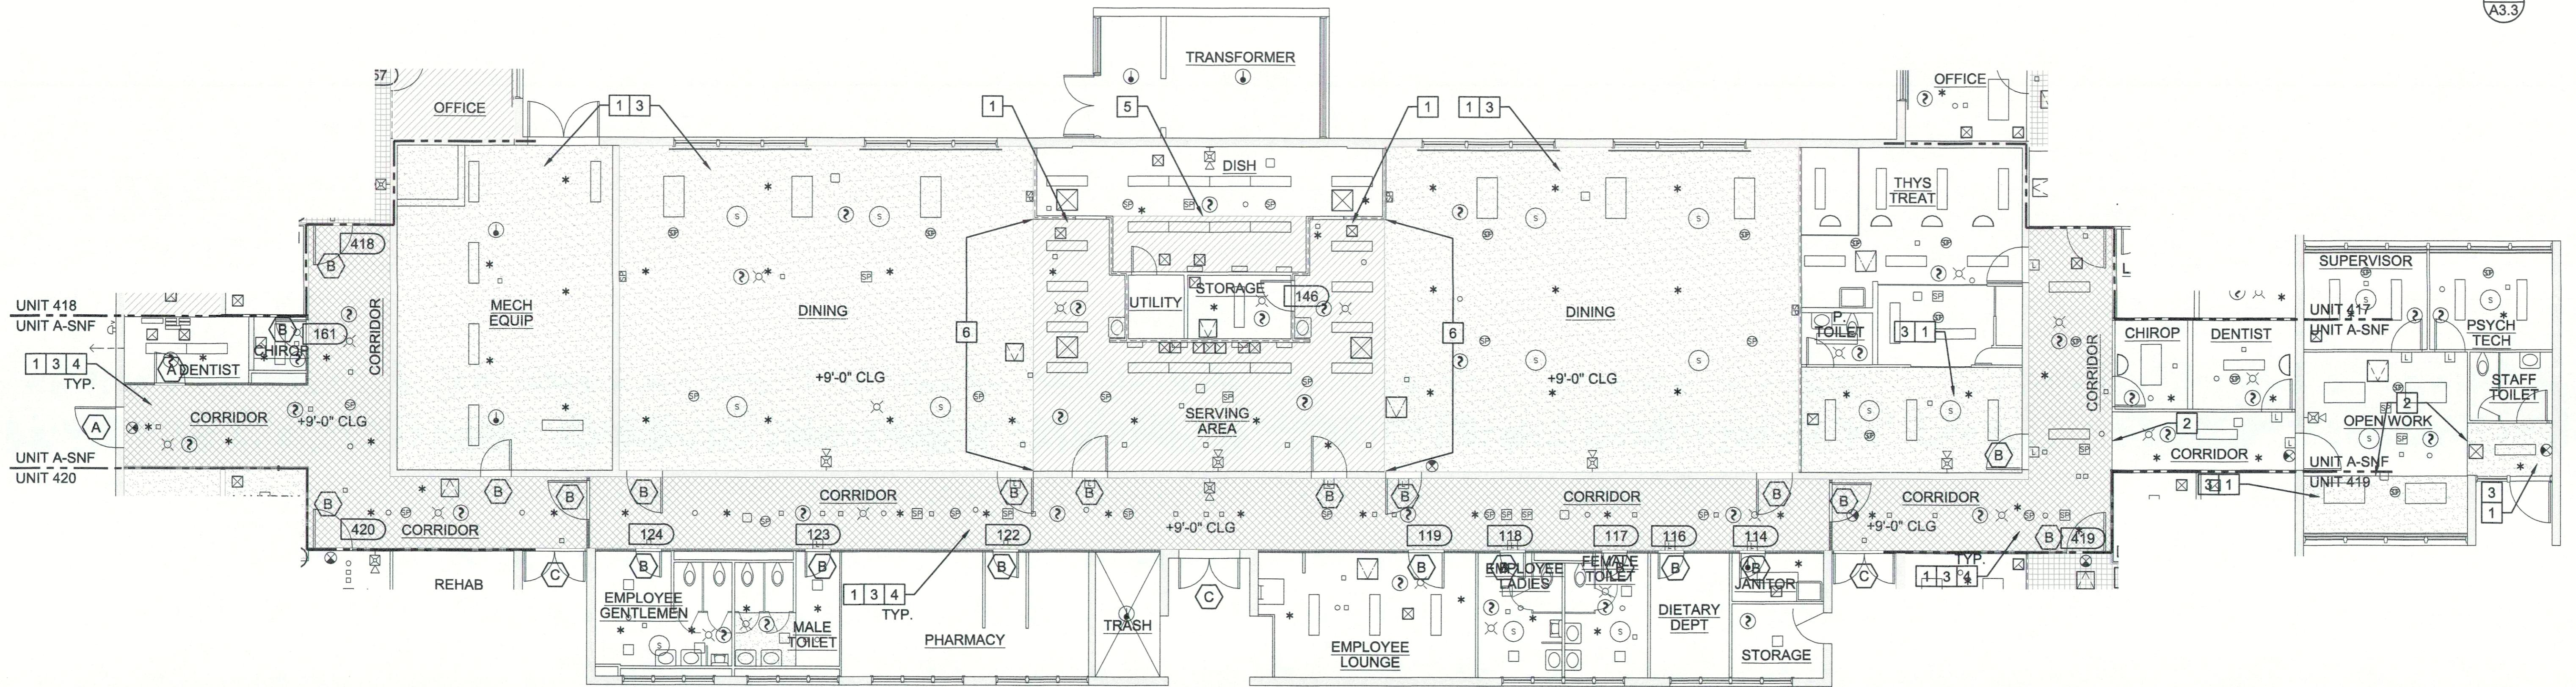

UNIT A SNF - CEILING FINISH PLAN

SCALE: 0 4 8 FEET 16
1/8" = 1'-0"

DOOR LEGEND:

SEE 6/A3.2 FOR DOOR TYPES


- (A) DOOR TYPE
- (B) DOOR TYPE
- (C) DOOR TYPE

CEILING LEGEND:

- 1 LAYER OF 5/8" TYPE C GYPSUM BOARD ON 2" C CHANNEL AND 7/8" HAT CHANNEL ^{4&5}_{A3.2}
- 1" GYPSUM PLASTER ON METAL LATH ²⁸³_{A3.2}
- 2" C CHANNEL AND 3/4" C CHANNEL
- 3 LAYERS OF 5/8" TYPE 'X' GYPSUM BOARD ON 4" METAL CEILING JOIST ^{3A}_{A3.1} ^{3B}_{A3.1}
- 1" CEMENT PLASTER ON METAL LATH ²⁸³_{A3.2}
- 2" C CHANNEL AND 3/4" C CHANNEL
- 1"x1" ADHERED ACOUSTIC TILES ON CEILING
- CURTAIN TRACK ON CEILING
- EXIT SIGN
- * FIRE SPRINKLER
- SPEAKER
- TWO WAY SPEAKER
- WIRELESS ACCESS POINTS
- MISC. MEP DEVICES
- HEAT DETECTOR

WALL LEGEND:

- 8" CONCRETE WALL ⁵_{A3.1}
- 2-1/2" SOLID PLASTER WALL ^{4A}_{A3.1} ^{4B}_{A3.1}
- 4" PLASTER ON METAL STUD
- SMOKE DETECTOR
- FIRE ALARM STROBE
- SECURITY STROBE
- FIRE ALARM CHIME STROBE WALL MOUNTED
- NOTIFICATION/CALL LIGHT
- ACCESS PANEL
- AIR TERMINALS (VARIOUS TYPES & SIZE)
- LIGHTING FIXTURES (VARIOUS TYPES & SIZE)

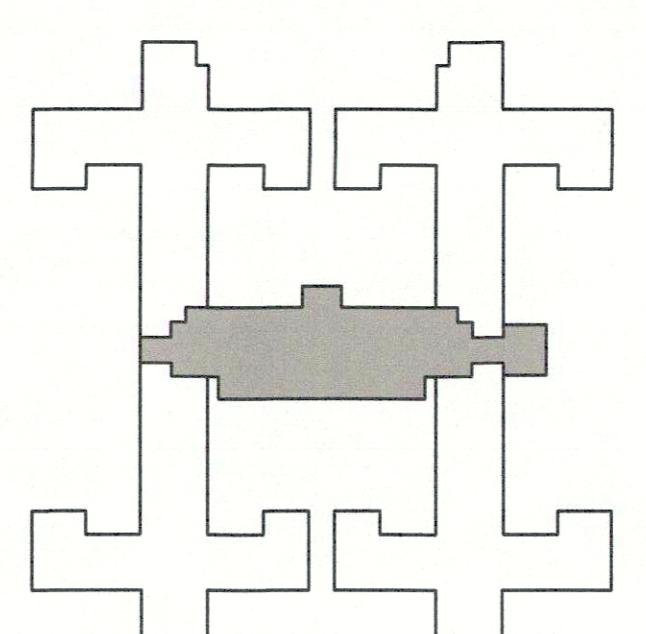


S.N.F. BUILDING KEYPLAN

N | M | L | K | J | I | H | G | F | E | D | C | B | A

WALL LEGEND:

- 8" CONCRETE WALL 5
A3.1
- 2-1/2" SOLID PLASTER WALL 4A
4B
A3.1
A3.1
- 4" PLASTER ON METAL STUD

DSA STAMP

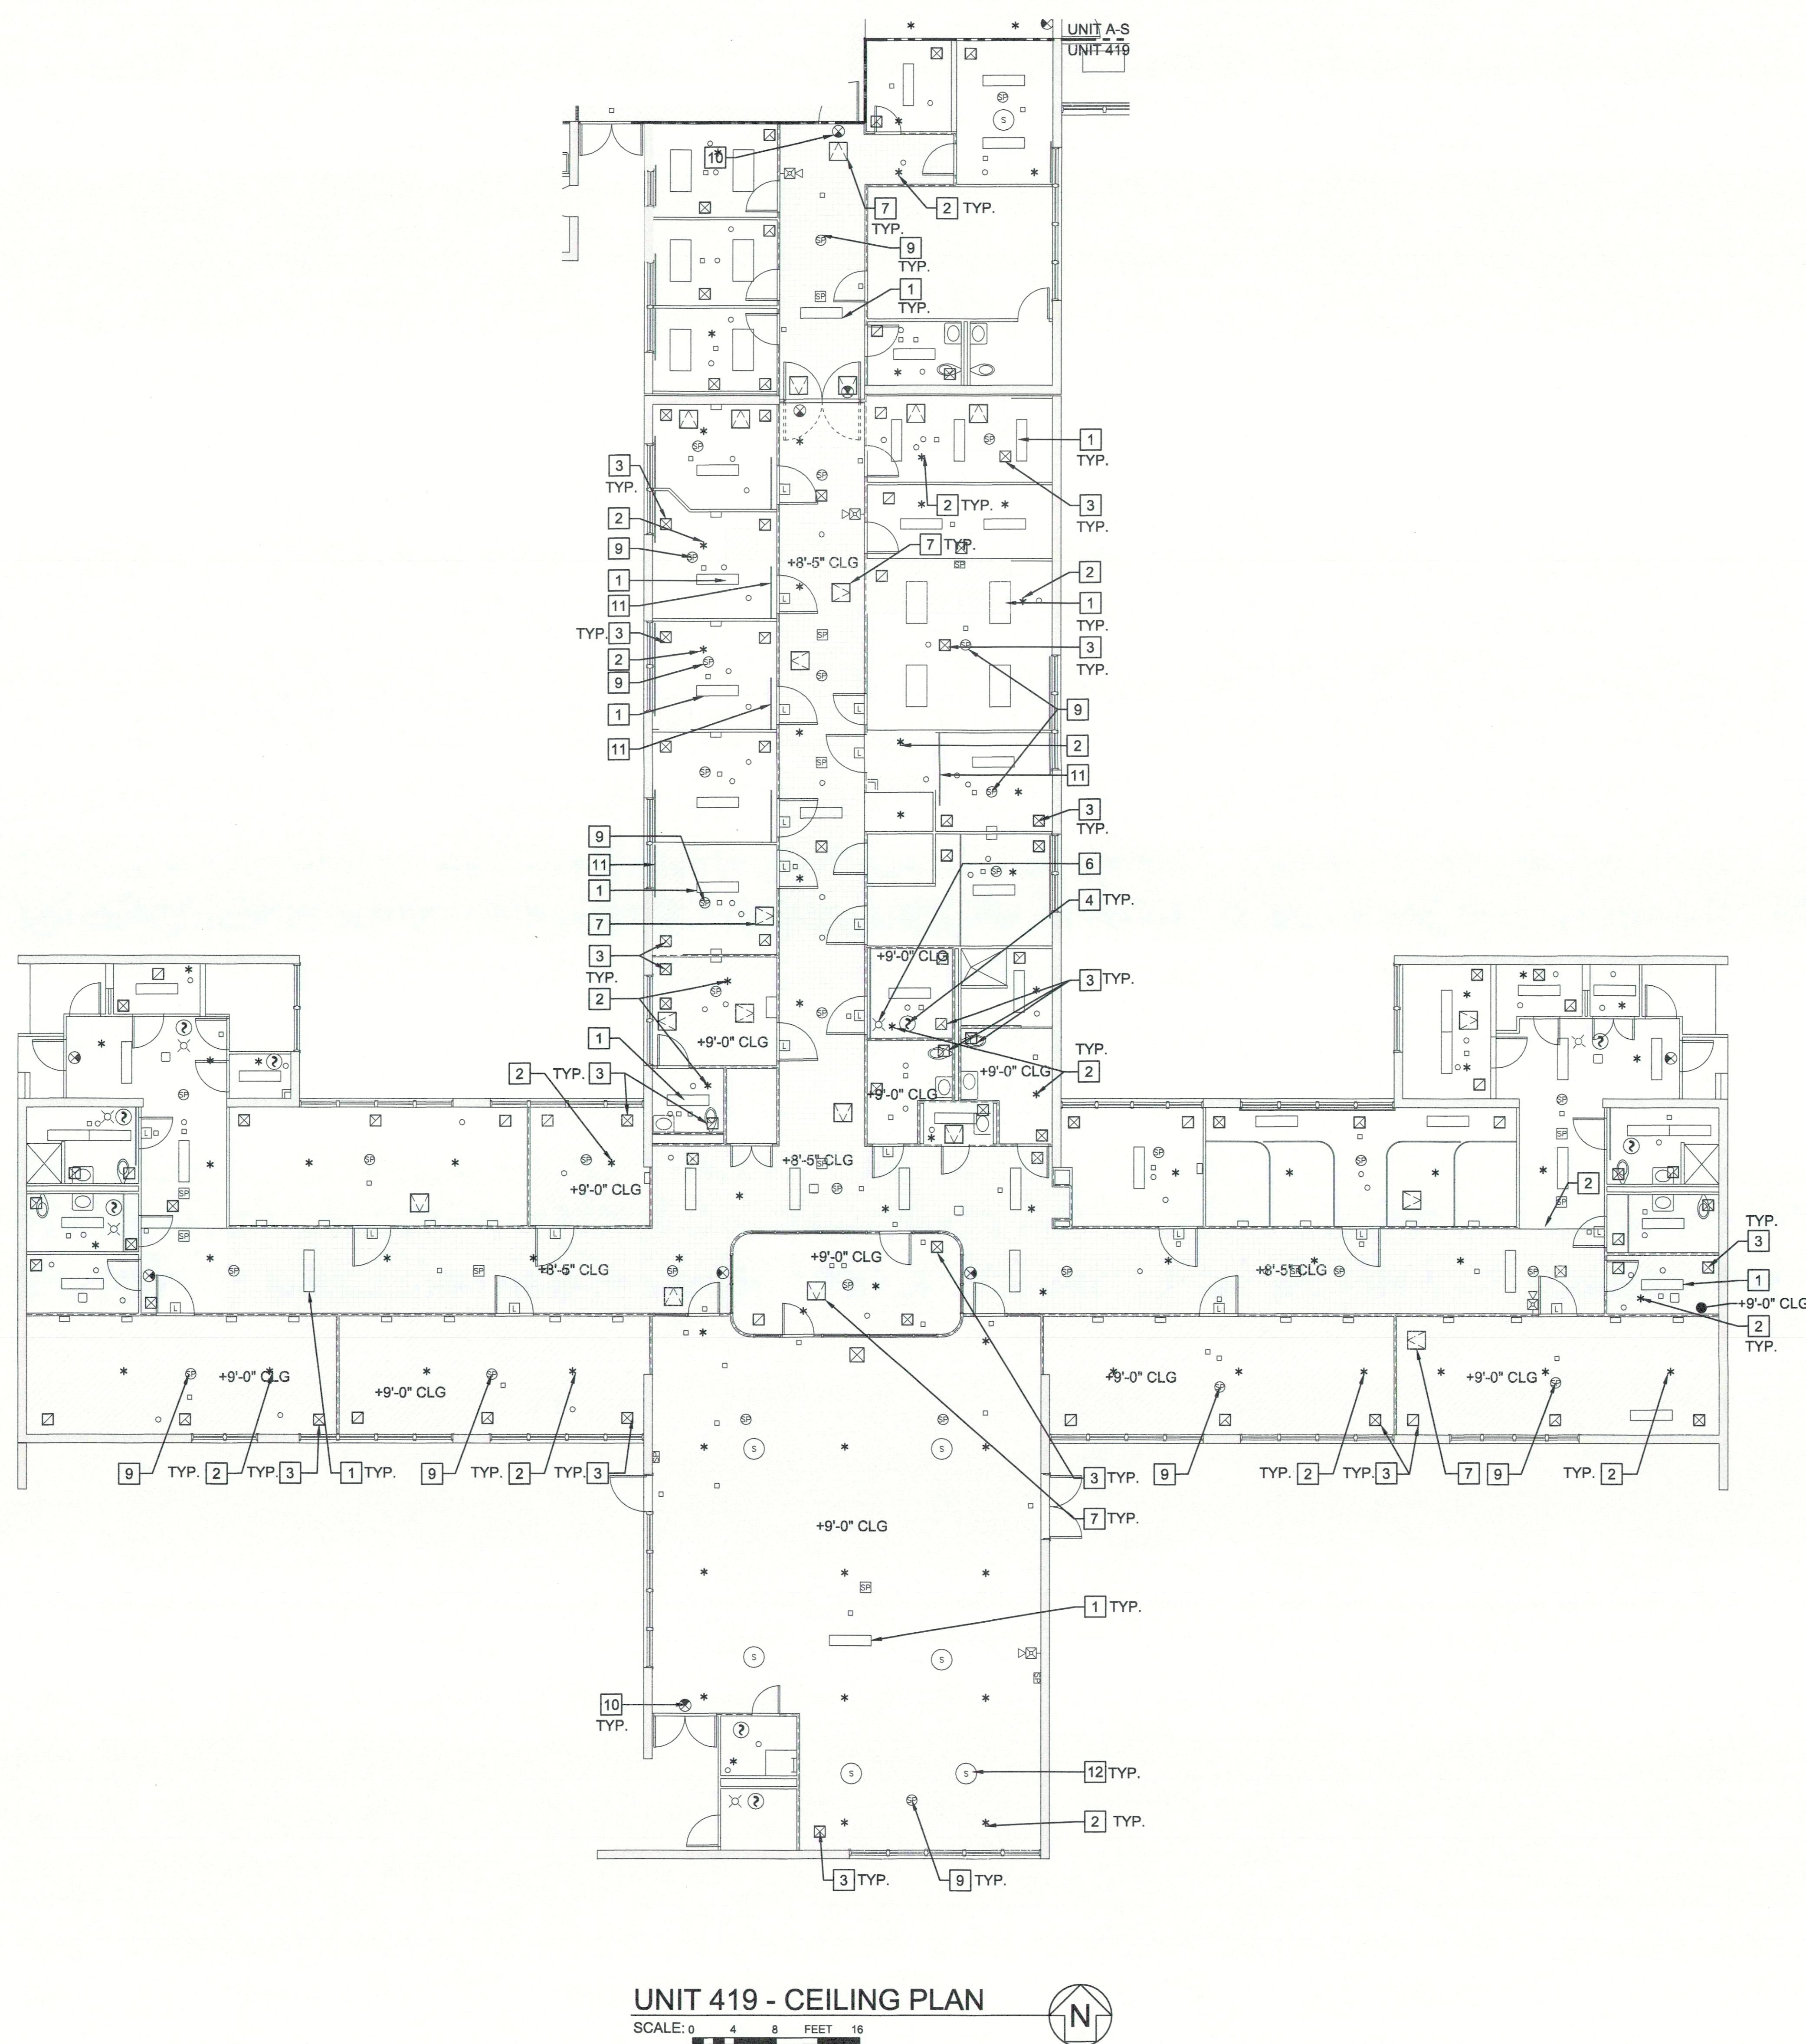

UNIT 419 - CEILING PLAN

SCALE: 0 4 8 FEET 16

1/8" = 1'-0"



NEW WORK KEYNOTES:

- (E) - EXISTING
(N) - NEW
- 1 CEILING MOUNTED LIGHT FIXTURE (N.I.C.) - (E) CONDUIT AND TERMINATION AT CEILING FINISH TO REMAIN FOR FUTURE LIGHT FIXTURE INSTALLATION. EXTEND CONDUIT WHEN THICKNESS OF CEILING FINISH CHANGED. 3 587
A3.3 A3.3
- 2 (E) FIRE SPRINKLER HEAD - LOWER F.S. HEAD WHEN THICKNESS OF CEILING FINISH CHANGED. REUSE (E) BRACKET TO ATTACH. PROVIDE THE MANUFACTURER'S APPROVED BRACKET WITH FURRING CHANNEL TO (E) CEILING FRAMING. 11
A3.3
- 3 (E) AIR SUPPLY & RETURN GRILLE - REMOVE AND REINSTALL 688
A3.3
- 4 (E) CEILING MOUNTED SMOKE DETECTOR. REINSTALL AFTER CONSTRUCTION IS FINISHED.
- 5 (E) CEILING MOUNTED HEAT DETECTOR. REINSTALL AFTER CONSTRUCTION IS FINISHED.
- 6 (E) CEILING MOUNTED FIRE ALARM WITH COVER
- 7 (E) CEILING MOUNTED ACCESS DOOR & SUPPORT FRAMING 9
A3.3
- 8 NOT USED.
- 9 (E) RECESSED CEILING MOUNT SPEAKER. PROVIDE FIRE RATED HOUSING OR COVER.
- 10 (E) CEILING MOUNT EXIT SIGN - REMOVE AND REINSTALL. EXTEND CONDUIT WHEN THICKNESS OF CEILING FINISH CHANGED.
- 11 (E) CURTAIN TRACK - REMOVE AND REINSTALL AT (E) SUPPORT
- 12 (E) GRILLE FOR EXHAUST FAN. REINSTALL AT (E) SUPPORT.

State of California
Department of General Services
Real Estate Services Division



Project Management Branch
707 Third Street, Suite 3-305
Sacramento, California 95605
Project Director:
(916) 449-8848 (Phone)
(916) 376-1677 (Fax)
www.dgs.ca.gov

A copy of this plan does not authorize or approve any omission or deviation from applicable regulations. Final approval is subject to review and approval by the appropriate authority. This plan shall be available on the project site at all times.

APR 19 2022

OFFICE OF THE STATE FIRE MARSHAL
APPROVED FOR APPROVAL ONLY
Reviewed by



JCCA J.C. CHANG & ASSOCIATES, INC.
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JCCA #17038-1

Issue:	18-S-1084-C-PI
No.	Date Description
-	11/01/21 FINAL DRAWINGS V1
-	3/2/22 FINAL DRAWINGS V2

Project
DSH-METROPOLITAN
SNF BLDG
RE-ROOF LEAK
DAMAGE REPAIR
PROJECT

11401 Bloomfield Ave.
Norwalk, CA. 90650
Los Angeles County
DGS PROJECT # DGS00000142412C
SFM FAC #19-19-43-0002

Supervisor Designed Drawn Checked
MJK V.L. MJK
File Date - Vault File Number -


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UNIT 419
CEILING PLAN

DSA Building Number --- Work Order -
Reference North Sheet Scale AS SHOWN
Sheet Number


A2.4

CEILING LEGEND:

- CURTAIN TRACK ON CEILING
- EXIT SIGN
- * FIRE SPRINKLER
- SPEAKER
- ◎ TWO WAY SPEAKER
- WIRELESS ACCESS POINTS
- MISC. MEP DEVICES
- HEAT DETECTOR
- ◎ SMOKE DETECTOR
- ⊗ FIRE ALARM STROBE
- ⊗ SECURITY STROBE
- ⊗ FIRE ALARM CHIME STROBE WALL MOUNTED
- NOTIFICATION/CALL LIGHT
- ACCESS PANEL
- AIR TERMINALS (VARIOUS TYPES & SIZE)
- LIGHTING FIXTURES (VARIOUS TYPES & SIZE)

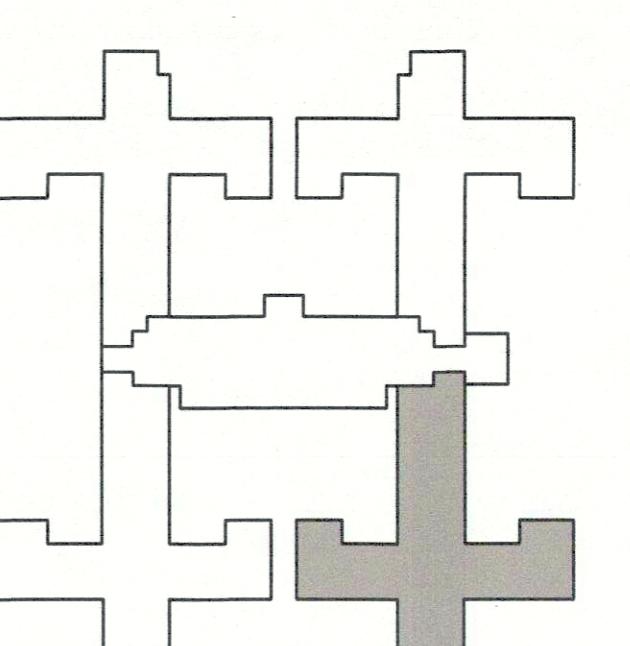

S.N.F. BUILDING KEYPLAN

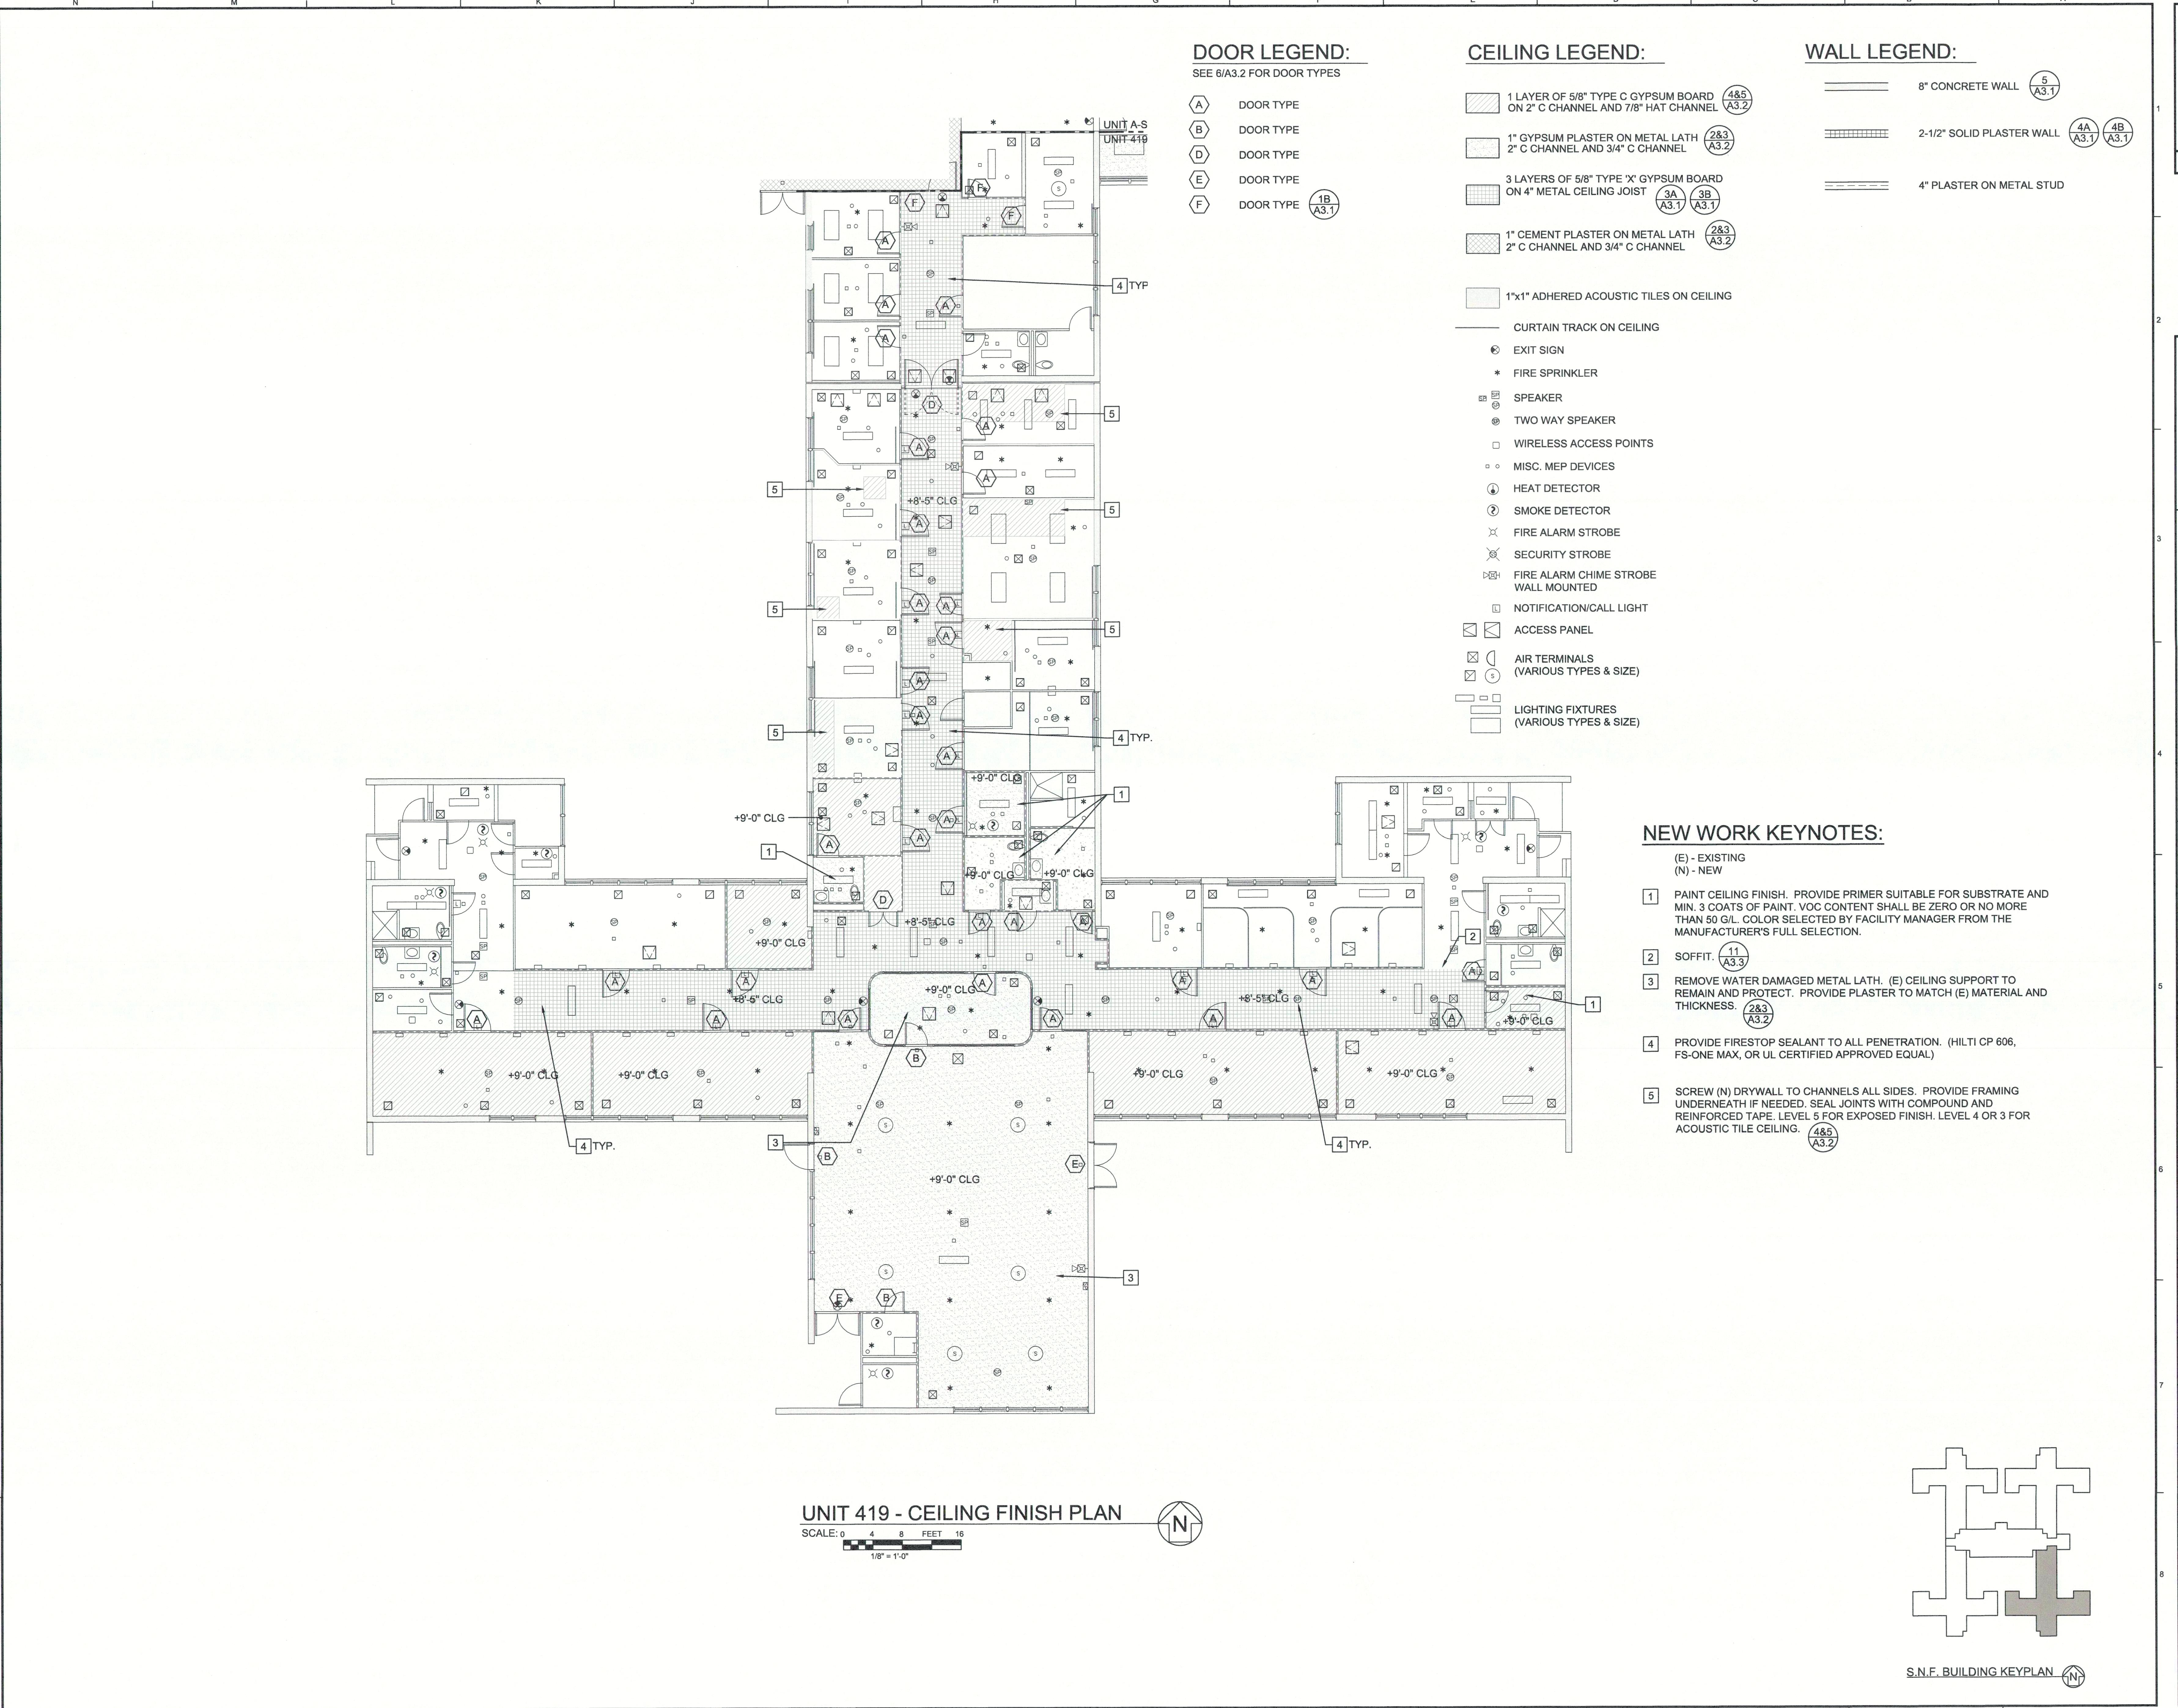

State of California
Department of General Services
Real Estate Services Division
DGS
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Sacramento, California 95605
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override any design or direction from
applicable regulations. Final approval is subject
to the State Fire Marshal's review. A copy
shall be available on the project site at all times.

APR 19 2022

OFFICE OF THE STATE FIRE MARSHAL
APPROVED BY: [Signature] DSM III
Reviewed by: [Signature]

JCCA J.C. CHANG & ASSOCIATES, INC.
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JCCA #17038-1



Issue: 18-S-1084-C-PI
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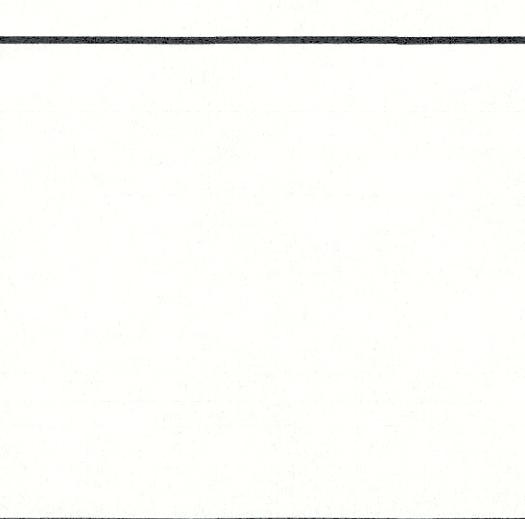
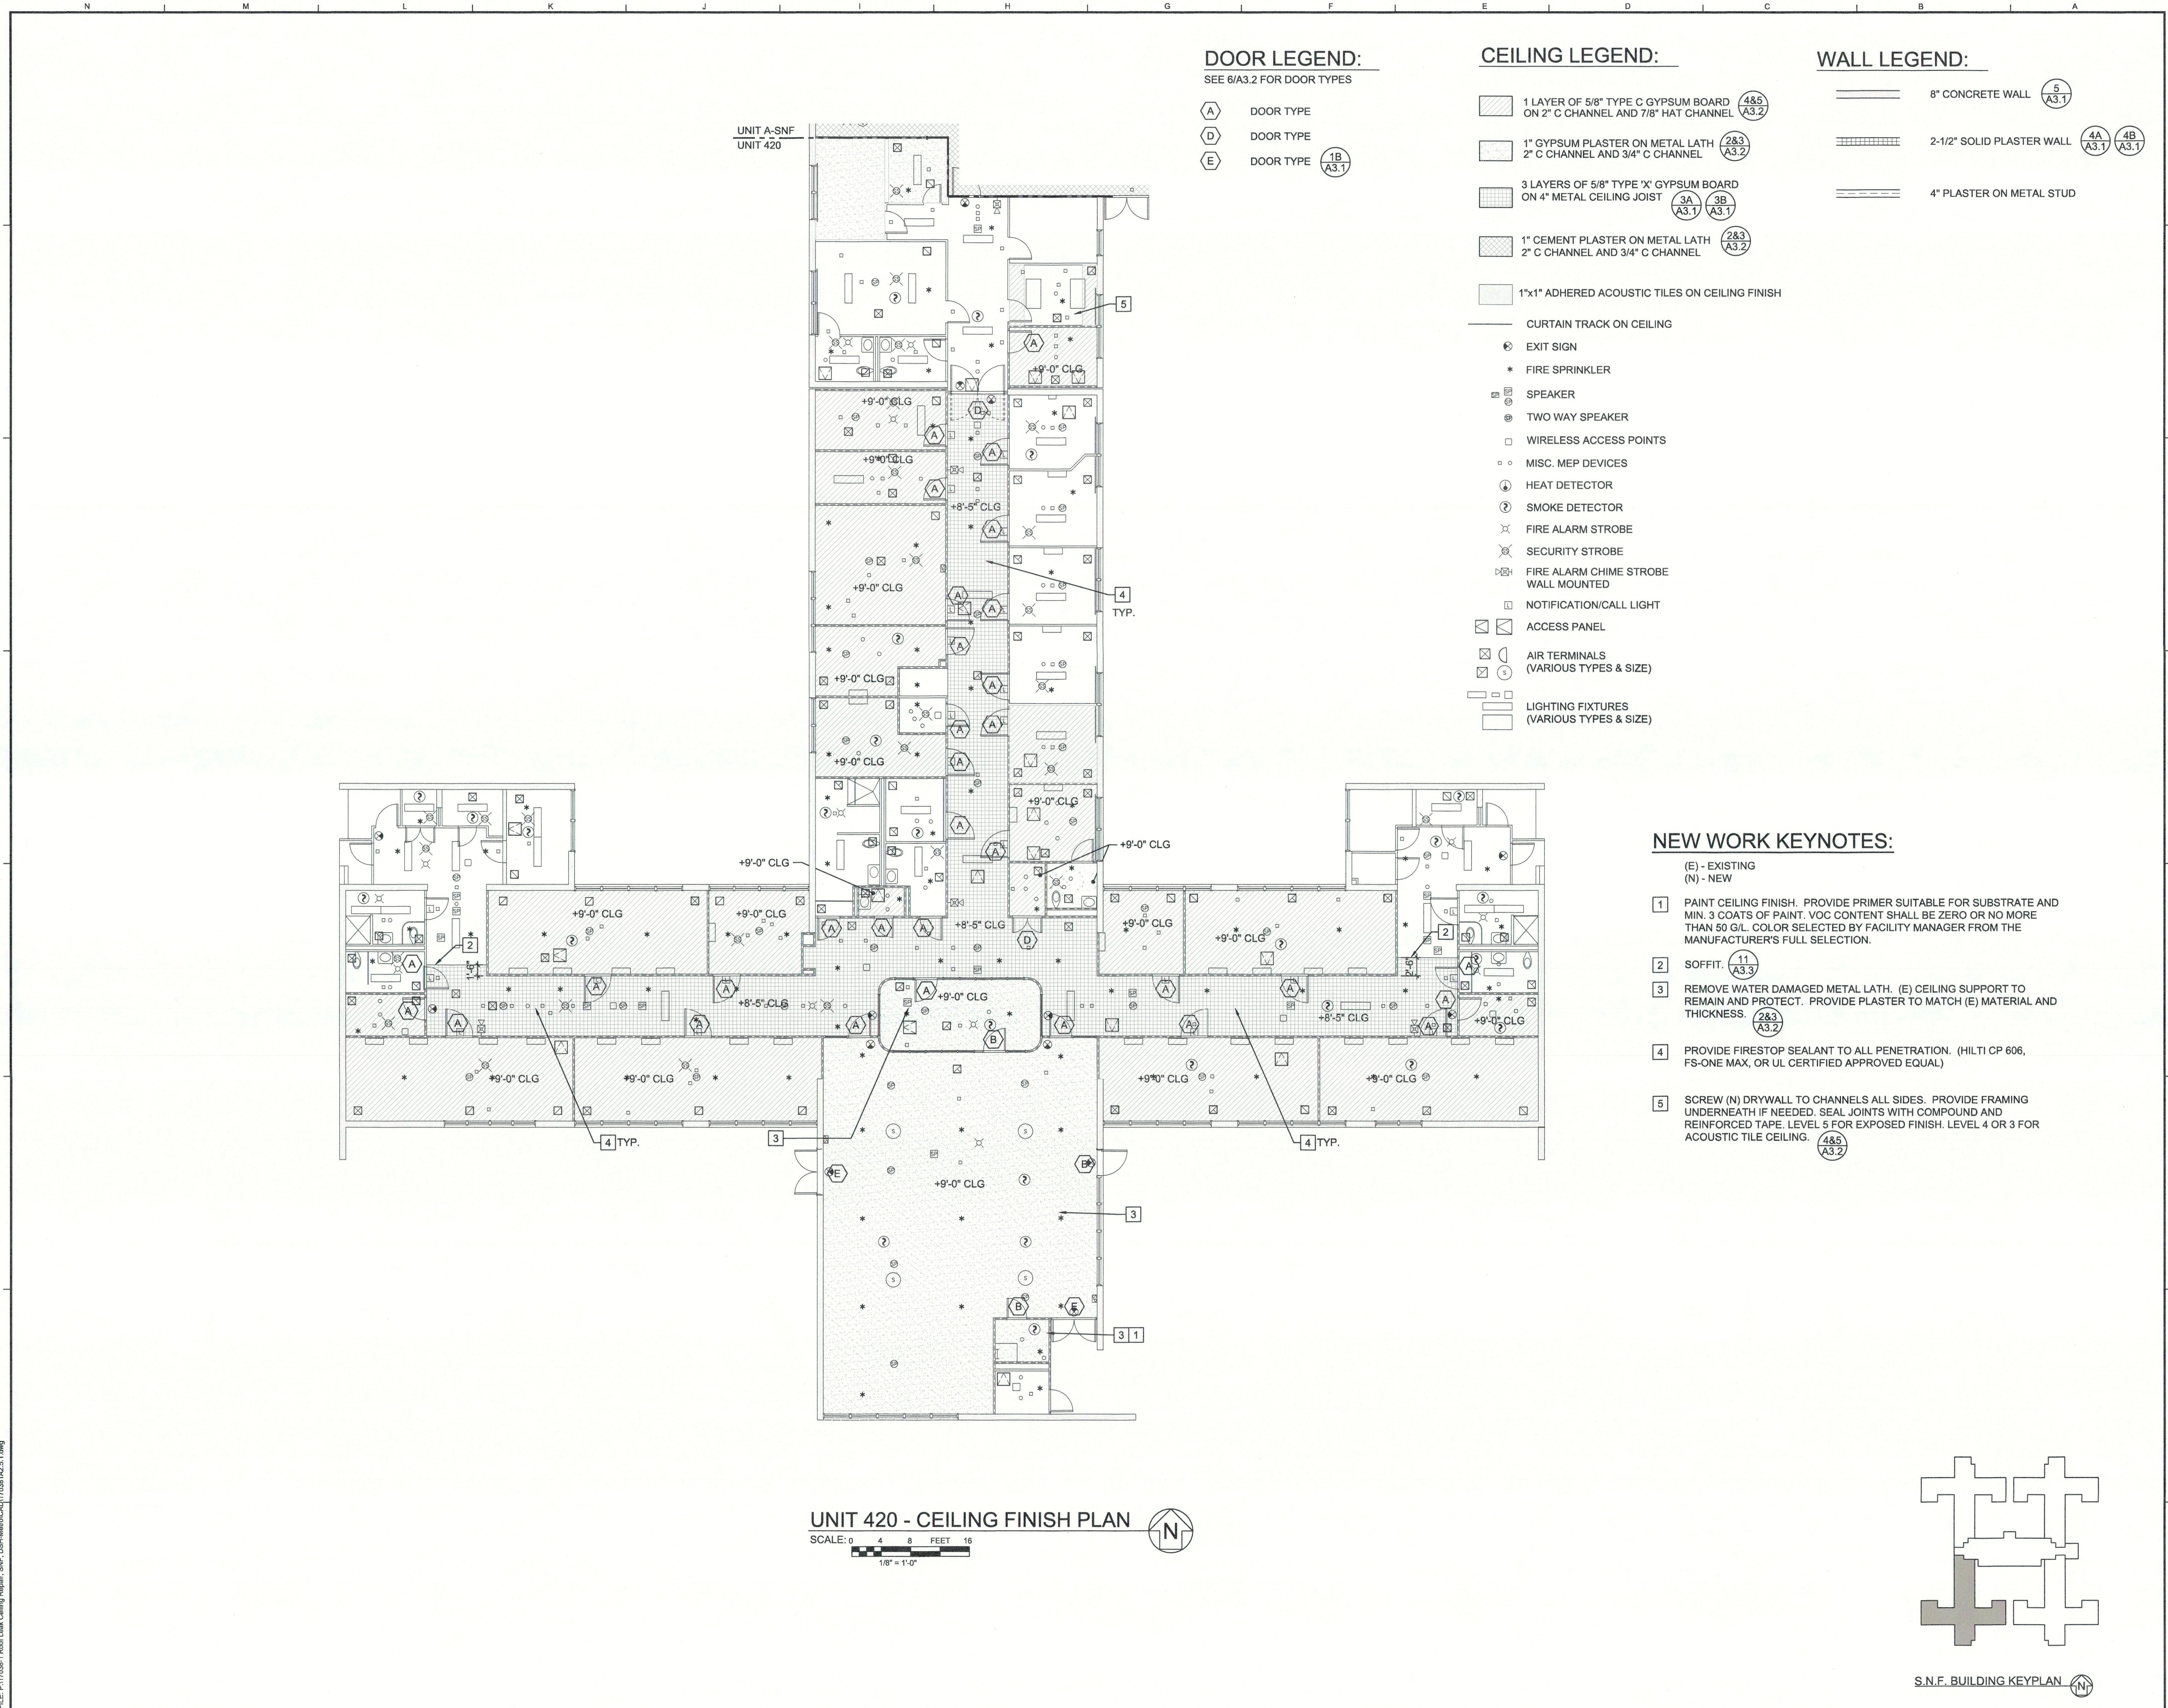
Project
DSH-METROPOLITAN SNF BLDG RE-ROOF LEAK DAMAGE REPAIR PROJECT
11401 Bloomfield Ave.
Norwalk, CA, 90650
Los Angeles County
DGS PROJECT # DGS00000142412C
SFM FAC #19-19-43-0002

Supervisor: MJK
Designed: Drawn: V.L.
Checked: MJK
File Date: Vault File Number:
Sheet Title: UNIT 419 CEILING FINISH PLAN

DSA Building Number: --- Work Order: ---
Reference North: Sheet Scale: AS SHOWN
Sheet Number: A2.4.1

PHASE 1 CEILING REPAIR - 3/24/22



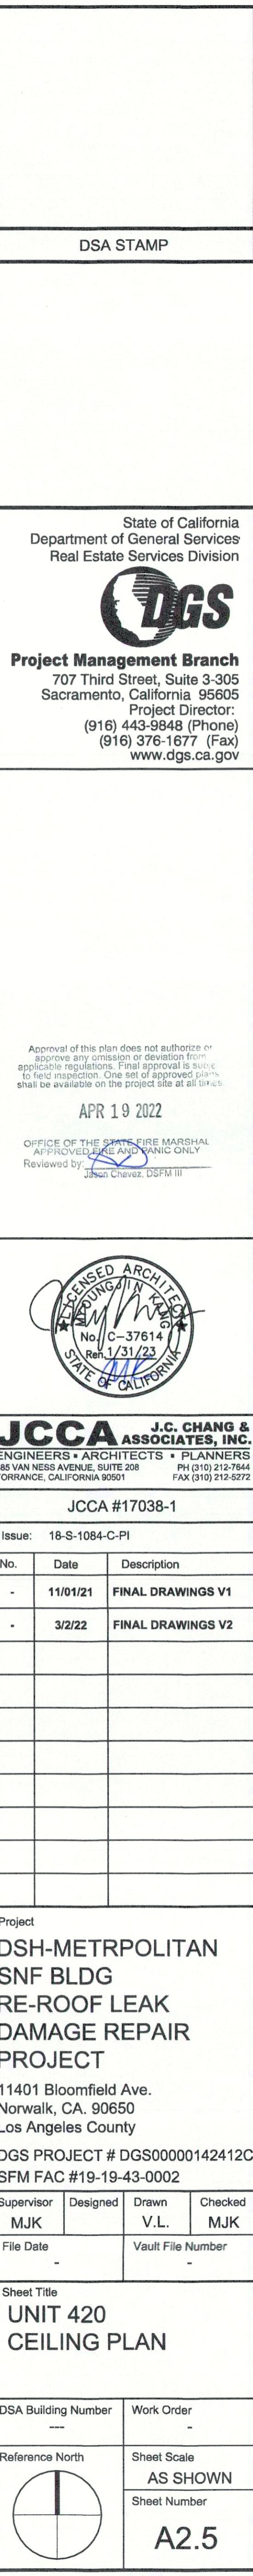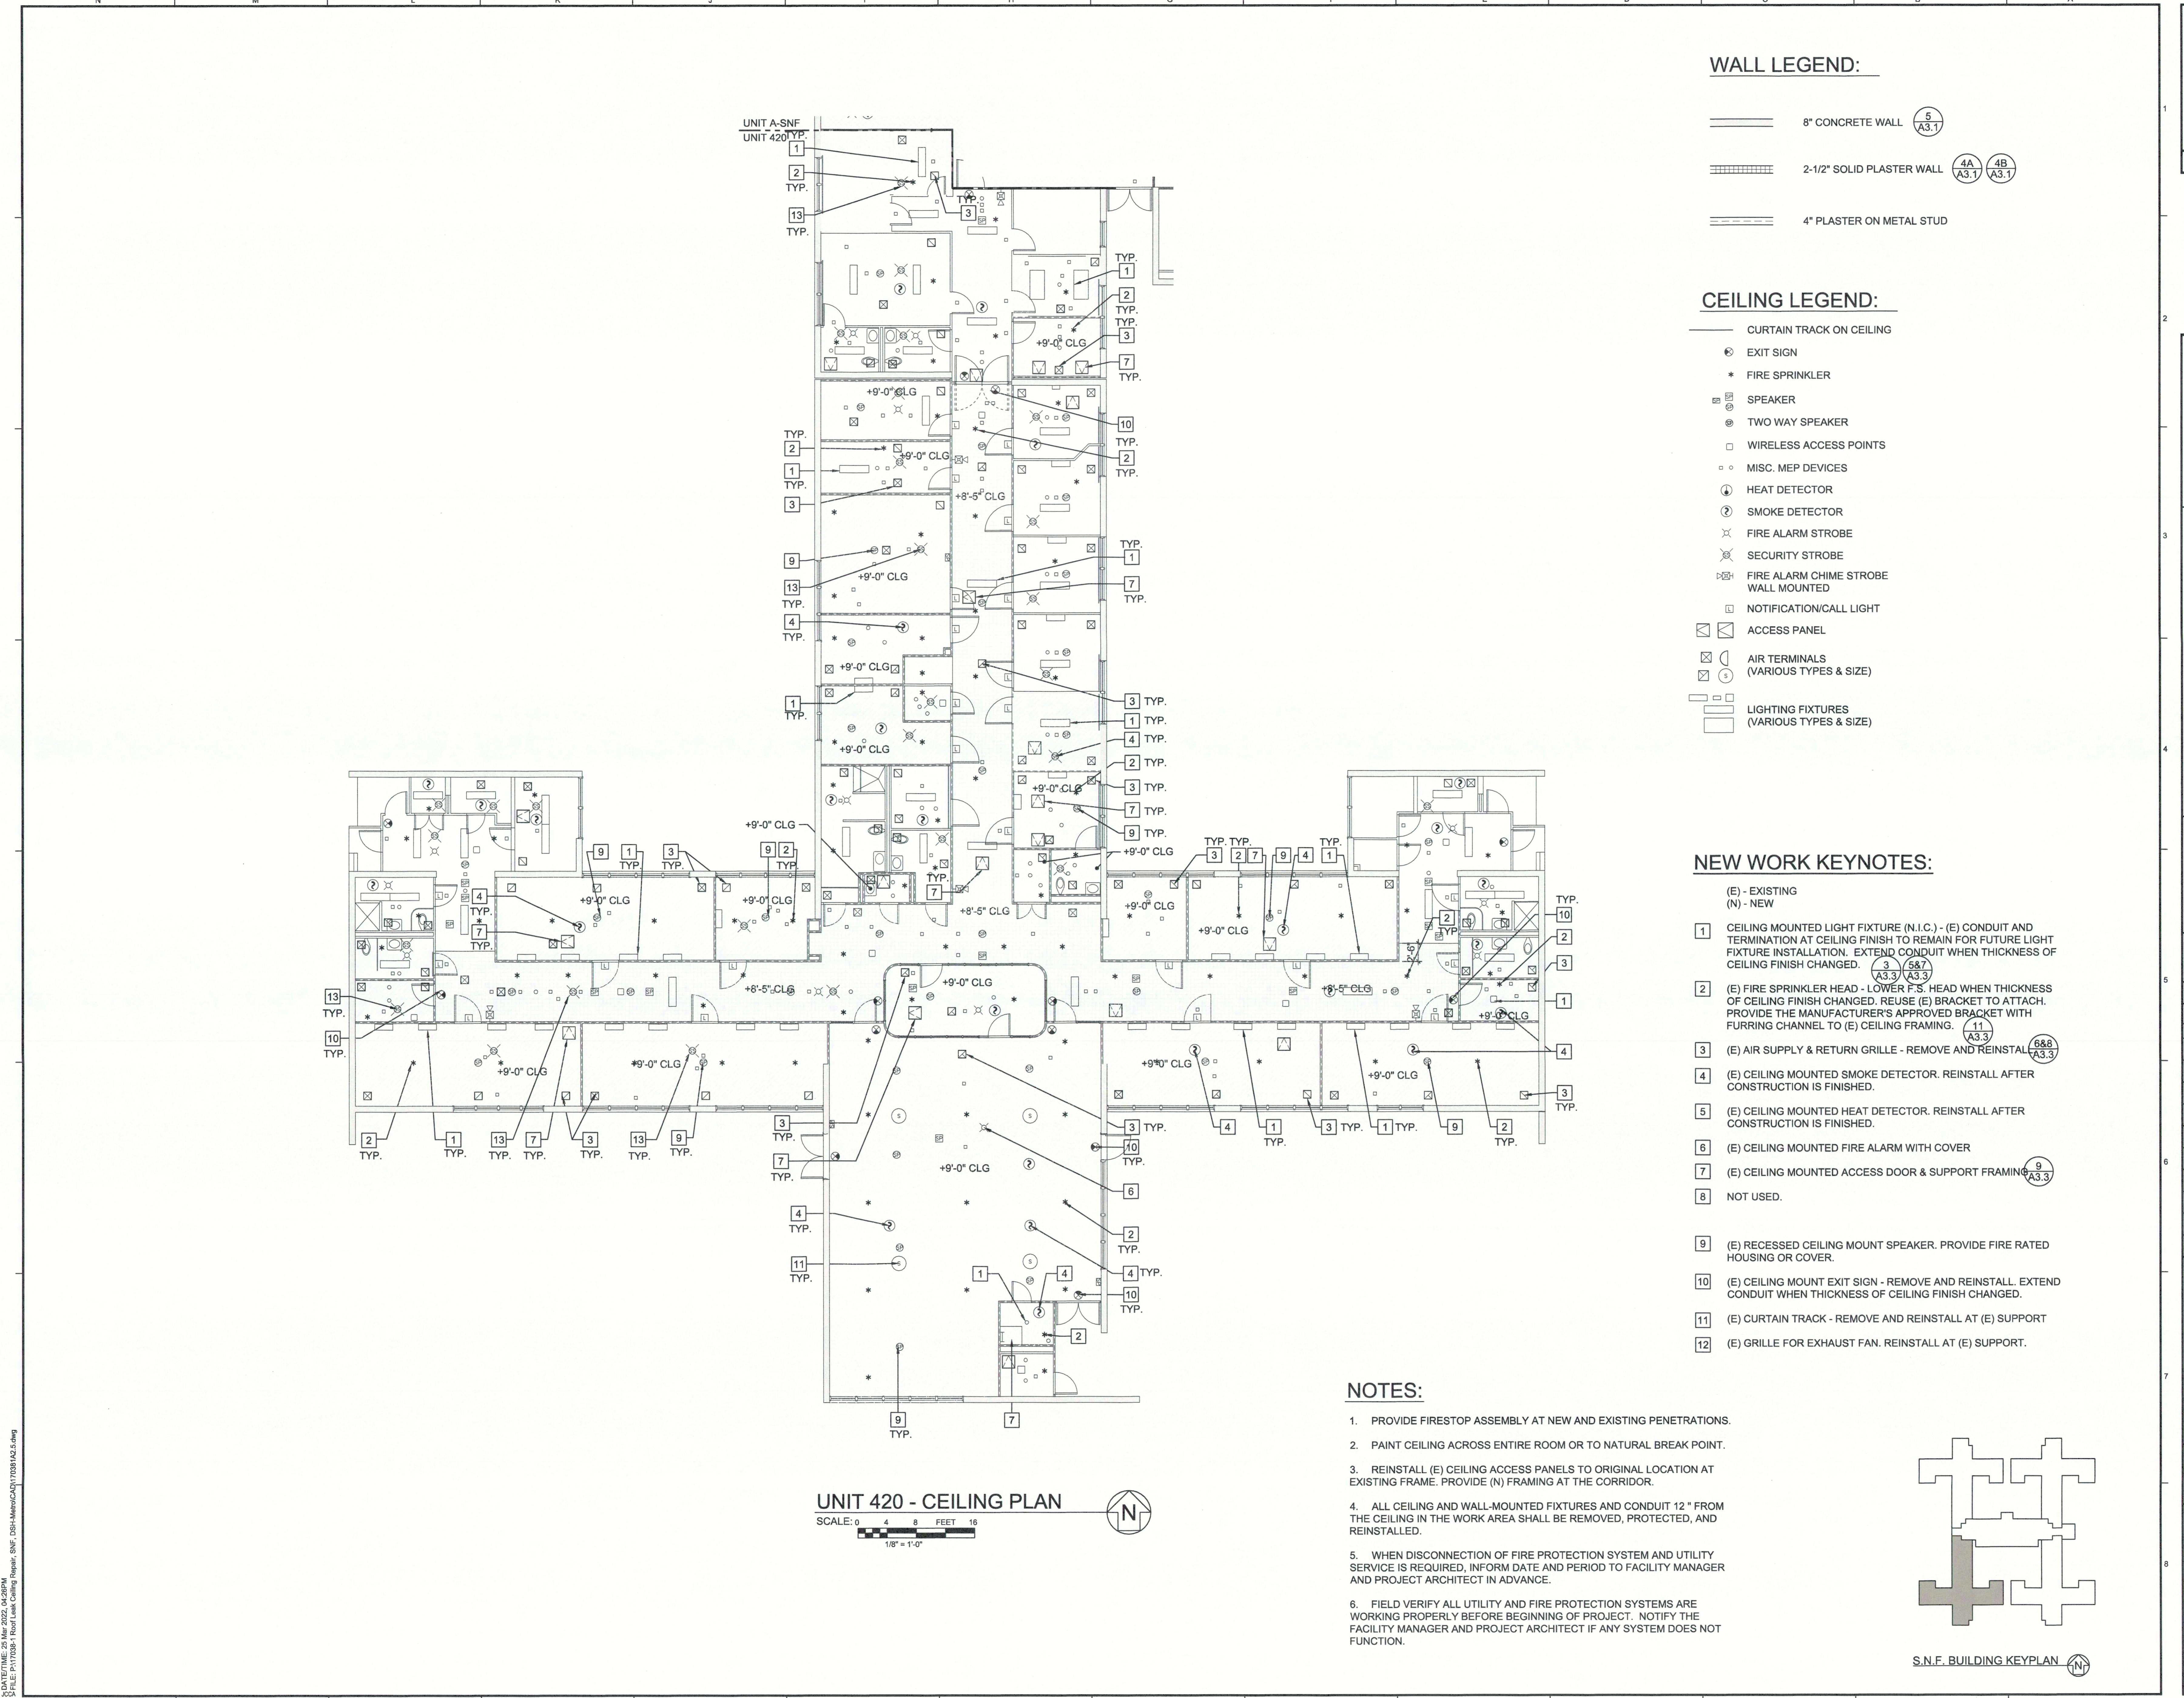

State of California
Department of General Services
Real Estate Services Division
DGS
Project Management Branch
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Project Director:
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Approval of this plan does not authorize or approve any omission or deviation from applicable regulations. Final approval is subject to inspection by the State Fire Marshal's Office. A copy of the approved plan shall be available on the project site at all times.

APR 19 2022

OFFICE OF THE STATE FIRE MARSHAL
APPROVED FOR PUBLIC PANIC ONLY
Reviewed by Jason [Signature] USFM III



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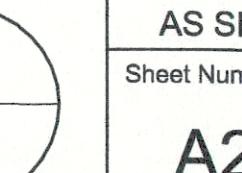
Issue: 18-S-1084-C-PI
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Project
DSH-METROPOLITAN SNF BLDG RE-ROOF LEAK DAMAGE REPAIR PROJECT
11401 Bloomfield Ave.
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Los Angeles County
DGS PROJECT # DGS00000142412C
SFM FAC #19-19-43-0002

Supervisor MJK Designed Drawn V.L. Checked V.L.
File Date - Vault File Number -


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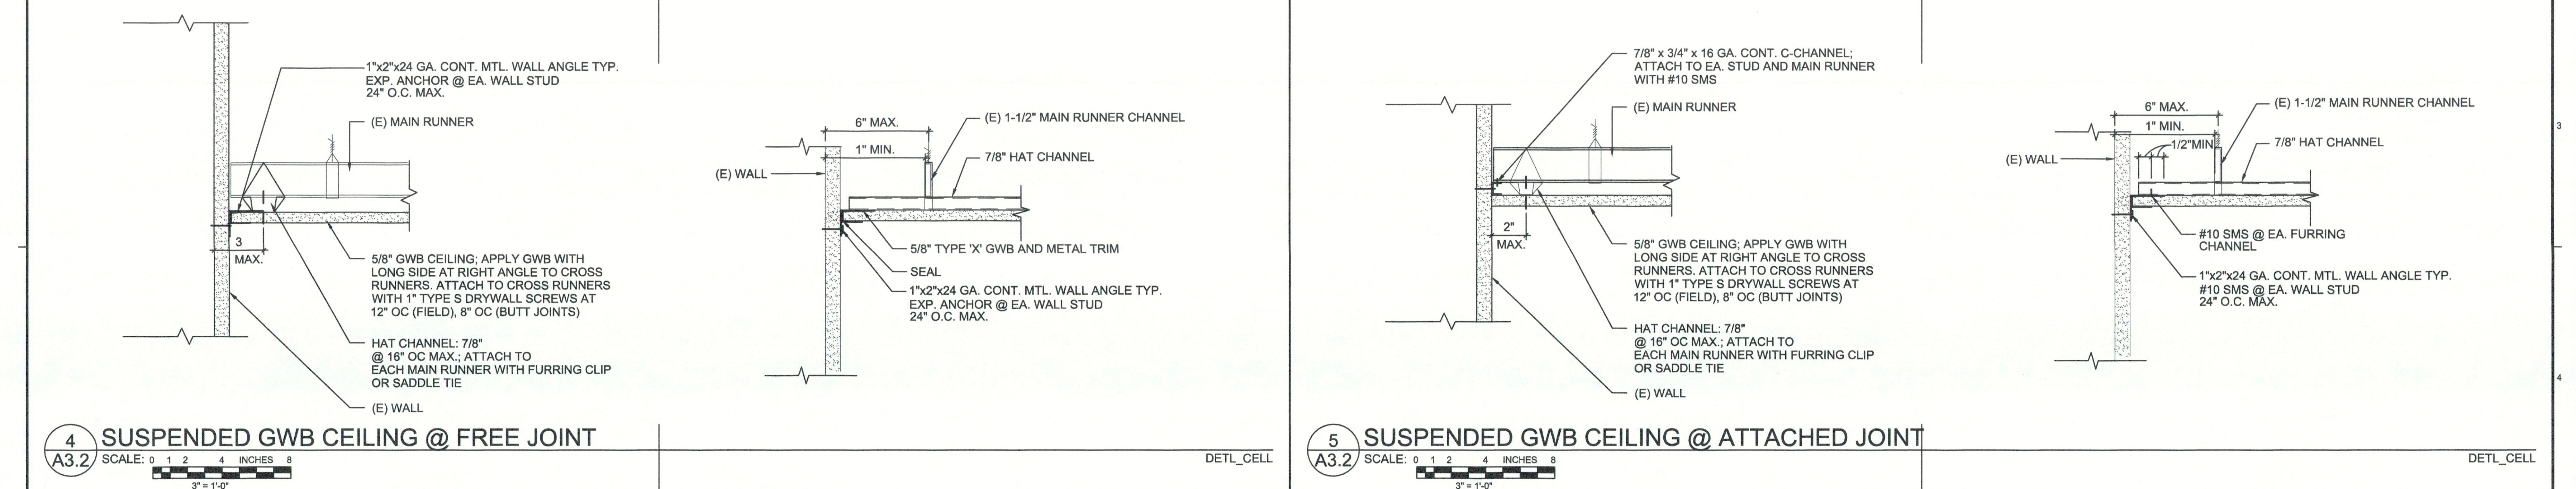
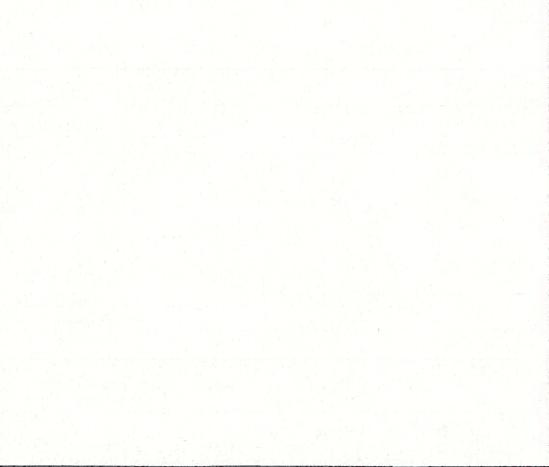
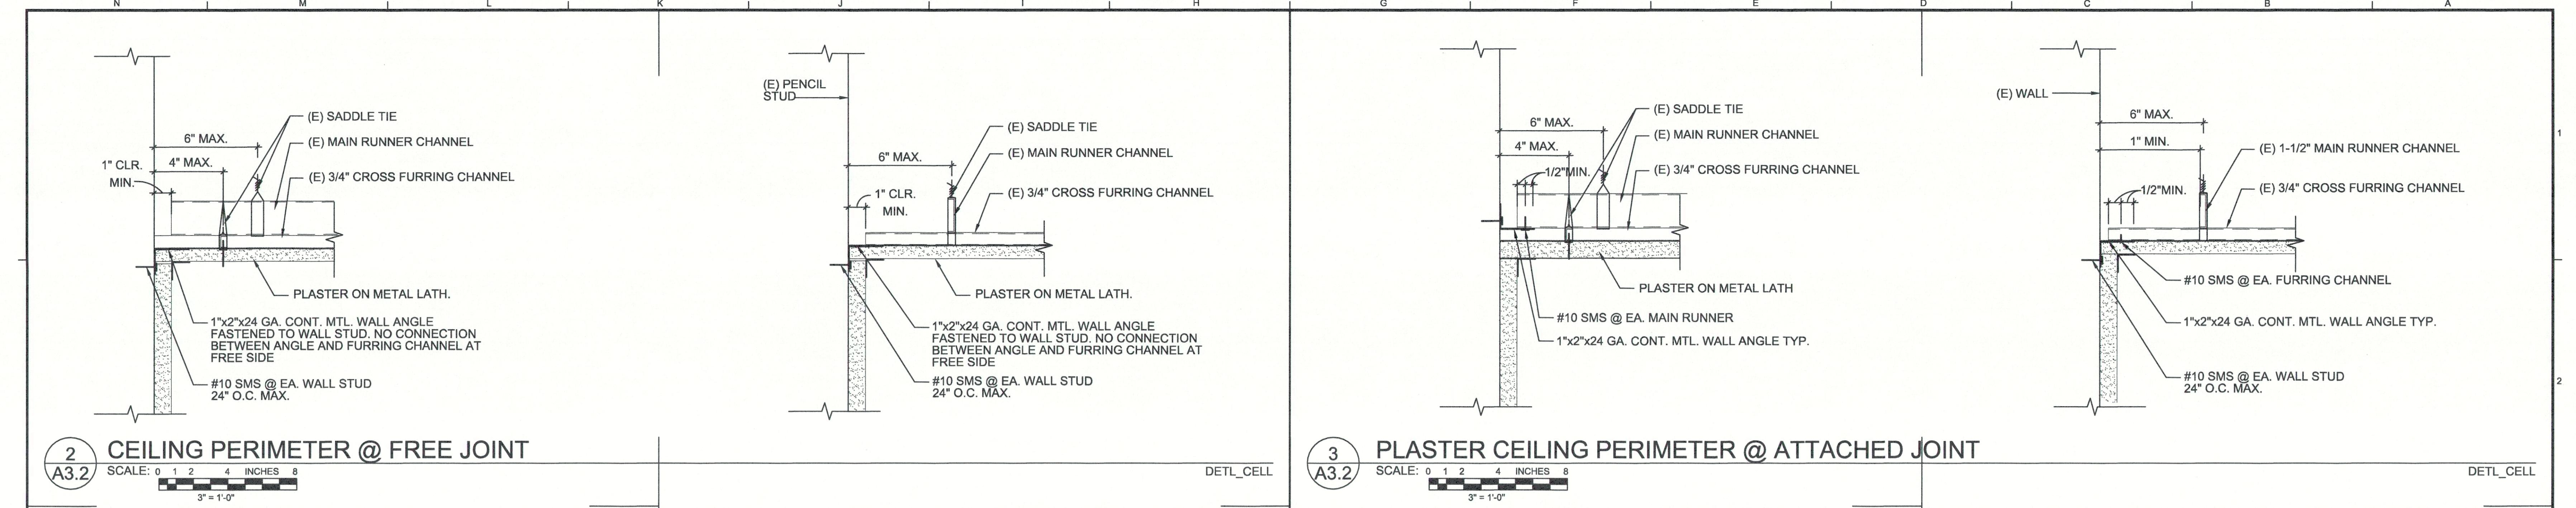
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Reference North Sheet Scale AS SHOWN
Sheet Number



A2.5.1

PHASE 1 CEILING REPAIR - 3/24/22



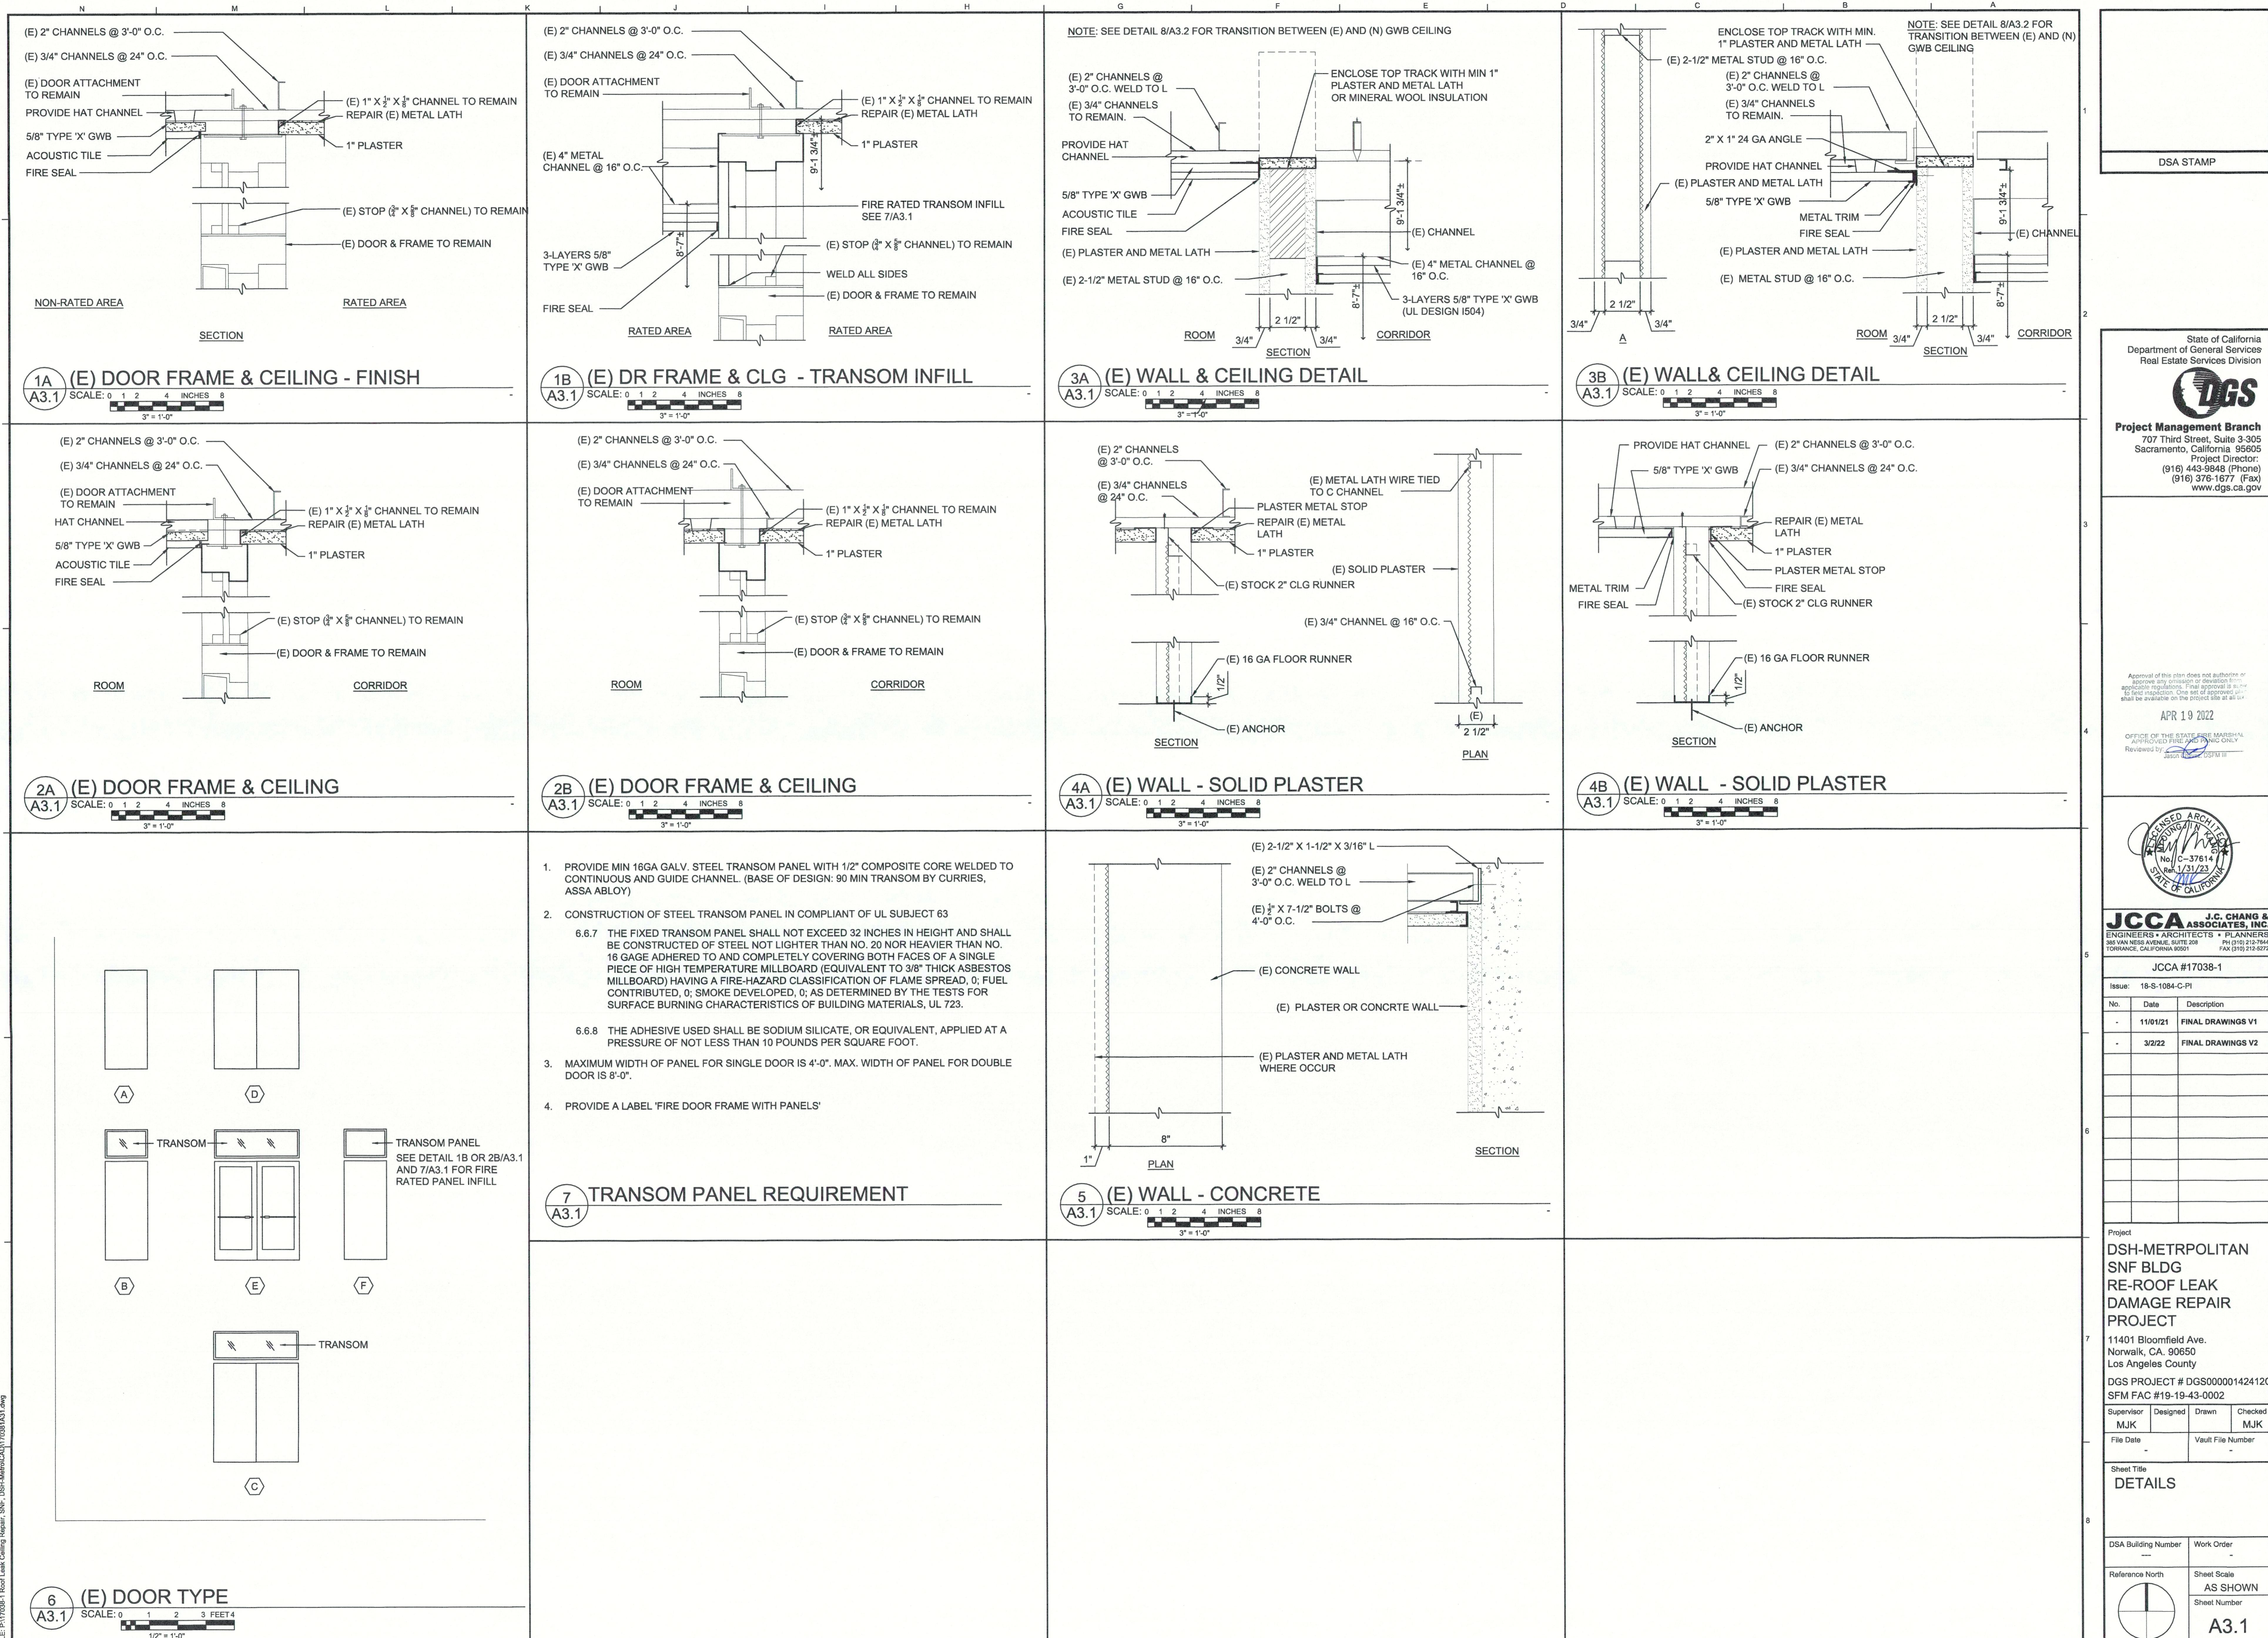

Issue:	18-S-1084-C-PI
No.	Date Description
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Project

DSH-METROPOLITAN SNF BLDG RE-ROOF LEAK DAMAGE REPAIR PROJECT

11401 Bloomfield Ave.
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DGS PROJECT # DGS0000142412C
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Supervisor _____ Designed _____ Drawn _____ Checked _____
File Date _____ Vault File Number _____

Sheet Title

DETAILS

DSA Building Number _____ Work Order _____

Reference North _____ Sheet Scale _____ AS SHOWN

Sheet Number _____

A3.2

- SUSPENSION SYSTEM COMPONENTS SHALL COMPLY WITH ASTM C754:
 - FURRING CHANNEL SHALL CONSIST OF MIN. 25 GAGE 7/8" (HAT) FURRING CHANNELS (087F125-18) at 2'-0" OC MAX. FURRING CHANNELS SHALL BE SADDLE TIED TO MAIN RUNNERS WITH 16 GAGE TIE WIRE OR A DOUBLE STRAND OF 18 GAGE TIE WIRE
 - FURRING CHANNELS SHALL BE SPLICED BY LAPING IN ACCORDANCE WITH DETAIL 4/A3.2.
- SUSPENSION SYSTEM INSTALLATION SHALL COMPLY WITH ASTM C754:
 - CEILING GRID MEMBERS SHALL BE ATTACHED TO TWO (2) ADJACENT WALLS. MAIN RUNNERS AND FURRING CHANNEL SHALL BE AT LEAST 1 INCH CLEAR OF OTHER WALL. IF WALLS RUN DIAGONAL TO THE CEILING GRID SYSTEM RUNNERS, ONE END OF MAIN RUNNER AND FURRING SHOULD BE FREE WITH STANDARD CLEARANCES.
- LATERAL FORCE BRACING:
 - EXCEPTION: LATERAL FORCE BRACING MAY BE OMITTED FOR SUSPENDED ACOUSTICAL CEILING SYSTEMS WITH A CEILING AREA OF 144 SQ. FT. OR LESS, WHEN PERIMETER SUPPORT ARE PROVIDED AND PERIMETER WALLS ARE DESIGNED TO CARRY THE CEILING LATERAL FORCES.
- CEILING FIXTURES, TERMINALS, AND DEVICES:
 - ALL FIXTURES SHALL BE SUPPORTED DIRECTLY BY MAIN RUNNERS OR BY SUPPLEMENTAL FRAMING WHICH IS SUPPORTED BY MAIN RUNNERS AND POSITIVELY ATTACHED WITH SCREWS OR OTHER APPROVED CONNECTORS.
 - SURFACE MOUNTED FIXTURES SHALL BE ATTACHED TO A MAIN RUNNER WITH A POSITIVE CLAMPING DEVICE MADE OF MATERIAL WITH A MINIMUM OF 14 GAGE. ROTATIONAL SPRING CLAMPS DO NOT COMPLY.
 - SMALL ACCESS PANELS FOR THE INSPECTION, ADJUSTMENT, OR REPAIR OF UTILITY SWITCHES, VALVES, SENSORS, ETC. MAY BE ALLOWED IF THE PANEL IS LESS THAN 300 SQUARE INCHES. SUCH PANELS SHALL ALSO HAVE A PERMANENT WARNING LABEL AS FOLLOWS:
 - WARNING: DO NOT CLIMB, WALK, OR CRAWL ON THE GYPSUM BOARD CEILING.
 - WARNING: DO NOT STORE OR STOW ANYTHING ON THE GYPSUM BOARD CEILING.
 - ALL LIGHT FIXTURES WEIGHING LESS THAN OR EQUAL TO 10 LB. SHALL HAVE ONE NO. 12 GAUGE SAFETY WIRE CONNECTED FROM FIXTURE HOUSING TO STRUCTURE ABOVE. IT IS NOT NECESSARY FOR THESE SAFETY WIRES TO BE TAUT.
 - ALL FIXTURES WEIGHING GREATER THAN 10 LB BUT LESS THAN OR EQUAL TO 56 LB. SHALL HAVE TWO NO. 12 GAUGE SAFETY WIRE CONNECTED FROM FIXTURE HOUSING TO STRUCTURE ABOVE. IT IS NOT NECESSARY FOR THESE SAFETY WIRES TO BE TAUT.
 - ALL FIXTURES WEIGHING GREATER THAN 56 LB. SHALL BE SUPPORTED DIRECTLY FROM STRUCTURE ABOVE BY APPROVED HANGERS.
- GYPSUM BOARD INSTALLATION SHALL COMPLY WITH ASTM C840-11:
 - GYPSUM BOARD SHALL CONSIST OF SINGLE-PLY 5/8" THICK IN ACCORDANCE WITH ASTM C11-10a.
 - GYPSUM BOARD SHALL BE INSTALLED PERPENDICULAR TO FURRING WITH SCREWS AT 12" ON CENTER MAXIMUM, IN ACCORDANCE WITH ASTM C840-11.
 - GYPSUM BOARD SHALL BE ATTACHED TO FURRING/FRAMING WITH ASTM C1002-07 TYPE S (ASTM A568-11b GRADES 1018 TO 1022) SCREWS (NOT LESS THAN, NO. 6, WITH MAJOR DIAMETER NOT LESS THAN 0.136 IN).
- SUSPENDED PLASTER CEILINGS - 1" METAL LATH AND CEMENT PLASTER PROVIDE 2 HOUR FIRE RESISTIVE PERIODS OF CEILING PROTECTION FOR STEEL ROOF MEMBERS (UBC TABLE NO. 43-A)
- SUSPENDED GYPSUM BOARD CEILINGS - UL I504

